

PLANNING DESIGN AND CONSTRUCTION

REPORT TO THE PRESERVATION OF HISTORIC BUILDINGS & SITES COMMITTEE

To:	The PHBS Committee	For:	February 16, 2021 PHBSC meeting.
VIA:	Carlos Dougnac, Assistant Vice President, PDC	FROM:	Milo Zapata, Project Manager
REQUESTOR:	Facility Operations/Business Services	PRESENTERS:	Milo Zapata and Design/Builder Group

	PHASE:	Committee Responsibilities:	STATUS AND PRIOR COMMENTS:	DATE:
	Programming	The committee will evaluate general site suitability in relation to Federal & State obligations and University policies for historic and archeological preservation.		
Х	SCHEMATIC DESIGN	The committee will assess conformance with Federal, State and University standards for siting within historic sites, and addition to and renovation of historic building.	1 st Presentation for approval	2/16/2021
	DESIGN DEVELOPMENT	The committee will evaluate of appropriateness of design features and details.		

BACKGROUND INFORMATION:

PROJECT:

UF-668, Racquet Club Dining Renovations

SITE:

On Fletcher Drive & East West Road, north of the Infirmary (location map in presentation).

STATUS:

- This is a "Fast Track" project, delivered in a Design/Build format.
- We are currently finalizing the Program and working towards a GMP deliverable.
- Construction is to begin in March with the completion slated for August 2021.

OBJECTIVES:

• To obtain review/approval for the bump out on the east elevation of the building.

PROJECT PHASE AND PRESENTATION NARRATIVE:

Design Development

The Committees are being asked to approve the 'bump-out' building addition as shown.

ENCLOSURES:

- 1. Presentation
- 2. CMP Checklist



Racquet Club Dining Center Renovation





PROJECT LOCATION




EXISTING SITE


6

EXISTING



PROPOSED SITE

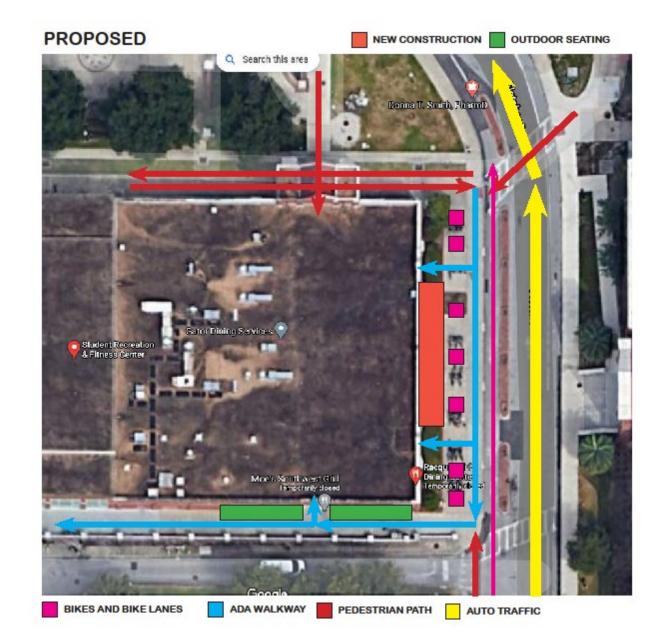

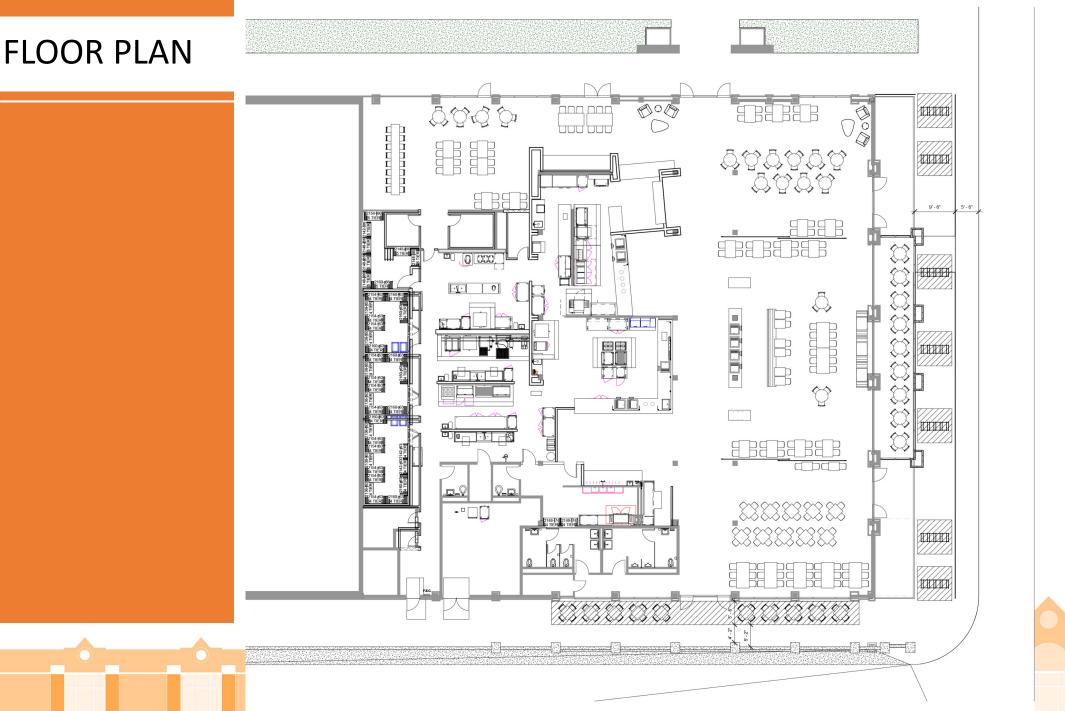

PROPOSED SITE



UNIVERSITY of FLORIDA BUSINESS AFFAIRS

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FACILITIES PLANNING AND CONSTRUCTION

	Campus Master Plan Checklist									
То:	ULUFPC, LVLC, PHBSC, P&TC DATE: 10/20/20 Project	ст: Т	JF-66	58 - Ra	acquet	Club	Dinin	g - Ren	iovati	ons
Prepared by					k			«		
This form is to specified phas	be completed for the applicable phase at the time that the project is reviewed by committees. Do not mark shaded c e. Checklists should be cumulative so that projects presented at Design Development have all phase columns comple . These checklist criteria apply to development on the main campus and, as applicable, on Satellite Properties in Alac	leted. De	esign-b							
					C	OMBIN	IE FOR	DESIG	N-BUIL	.D
EVALUATIO	IN CRITERIA	A	GRAMI ND SIT LECTI	ΤE	SCHEMATIC DESIGN Concept Advanced		DESIGN DEVELOPMENT			
		YES	NO	NA	YES	NO	NA	YES	NO	NA
1) The pro	AND USE AND FACILITIES PLANNING COMMITTEE (ULUFPC) oject appears in the Capital Improvements Element, Table 13-1 (Ten-Year Capital Projects List) and Figure 13-1 Building Sites)	Х						-	-	-
☐ As ⊠ W	s presented in the adopted Campus Master Plan ith edits to Table 13-1 to modify the project GSF or description ith edits to Figure 13-1 to modify or assign the project site									
a) If	"no" or with edits: The addition or modification of the project in the CMP can be accomplished as a Minor mendment (per UF Operating Memorandum) and without changing the Campus Development Agreement	Х						-	-	-
2) The pro	pject is consistent with the Future Land Use designation and definition (Figure 2-1, Future Land Use and Policies ind 1.1.8)	Х						-	-	-
, U	"no", the necessary modification to Figure 2-1 (Future Land Use) can be accomplished as a Minor Amendment (per F Operating Memorandum) and without changing the Campus Development Agreement			Х				-	-	-
support Policies Policy 2	bject location is consistent with policies that direct the location of specific uses (i.e. academic facilities, t/clinical facilities, housing, recreation/open space & parking) (<i>Academic Facilities, Policy 1.2.3; Support/Clinical,</i> s 1.1.3, 1.1.4 and 1.1.6; Housing, Policy 1.3.1; Recreation/Open Space, Policies 1.3.1 and 1.3.3; Transportation 2.5.4 and 2.5.6)	Х						-	-	-
, Th Acaden	ne project is not a temporary building; OR ne temporary building is located in the Surge Area, Energy Park, Physical Plant Division complex, nic/Research-Outdoor Future Land Use, or the temporary building supports construction activity <i>(Capital</i> <i>ements, Policy 1.1.15)</i>			X	-	-	-	-	-	-
Improve	oject considers life-cycle costing, pursues principles of sustainable design and/or seeks LEED certification (Capital ements, Policy 1.1.14)	Х								
located 13 th St)	ilding footprint, orientation and setback comply with Policy 1.3.1, Urban Design Element because the project is with road frontage along Stadium Rd (Gale Lemerand Dr to Buckman Dr), University Ave (Gale Lemerand Dr to SW, SW 13 th St, Center Drive, Museum Rd (west of Center Dr. to SW 13 th St), Archer Rd/SW 16 th Ave, or Radio Rd; or new centers of development (i.e. near Orthopaedics & Sports Med, Cultural Plaza, Southwest Recreation, and near Hall)		X							



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Campus Master Plan Checklist

				C	OMBIN	E FOR	DESIG	N-BUIL	.D
EVALUATION CRITERIA	PROGRAMMING AND SITE SELECTION		SCHEMATIC DESIGN Concept Advanced			[DEVI			
	YES	NO	NA	YES	NO	NA	YES	NO	NA
7) The project is a minimum of 3-stories; <u>OR</u> the project demonstrates unique programmatic, functional or code requirements that dictate a variance from the 3-story minimum; <u>OR</u> the project meets alternate building height and design characteristic requirements based on its location in unique areas of campus for which more specific building design requirements apply (i.e. near Orthopaedic & Sports Med, SW Research Circle/Cancer-Genetics area, Fifield Hall area, Cultural Plaza, Radio Road Commuter Lot area, Archer Road Corridor/Planning Sector "G", Historic Impact Area, PKY Developmental Research School and Eastside Campus) (<i>Urban Design, Policy 1.3.4 through 1.3.10</i>); <u>OR</u> the project meets guidance for building height and design of housing facilities (<i>Housing, Policy 1.3.2</i>)			X						
8) The project provides community design integration along campus perimeters as described in Policies 1.2.1 and 1.4.3, Urban Design Element, with respect to landscaping, hardscaping, views, signage, and bicycle/pedestrian accommodation as applicable because the project is located along Gateway Roads identified in Figure 1-6, Urban Design Element (i.e. University Ave, SW 2 nd Ave, SW 13 th St, Archer Rd, and SW 34 th St)	•	-	-						
 9) The project includes exterior public art; - Note: LVLC and PHBSC (if applicable) approval recommendation required OR D The project demonstrates that exterior installation of public art is infeasible or undesirable (Urban Design, Policies 1.6.2, 1.6.3 and 1.6.4) 	-	-	-						
10) Utilities and associated support structures are installed underground or are appropriately screened from view by decorative architectural walls or landscaping (<i>Electric Power and Other Fuels Sub-Element, Policy 2.1.7 and 2.1.8</i>)	-	-	-						
PRESERVATION OF HISTORIC BUILDINGS AND SITES COMMITTEE (PHBSC) – Note: see also #9 above									
 11) The project meets the requirements of the University's Memorandum of Agreement with the State Division of Historical Resources because The site is located adjacent to an Archaeological Site or within an Archaeological Sensitivity Zone (Urban Design, Policy 1.7.1): <u>AND/OR</u> Mathematical The project is new construction or a building addition located within the Historic District or Historic Impact Area depicted on Figure 1-2, Urban Design Element; <u>AND/OR</u> The project includes renovation, rehabilitation or restoration of an existing structure that meets the definition of "historic property" described in Policy 1.5.4 of the Facilities Maintenance Element 	X								
 a) If "yes" for new construction or building additions, the project design is sensitive to the orientation and character defining features of existing structures in the Historic Impact Area (<i>Urban Design, Policy 1.7.2</i>); with a building height between 2 and 5 stories not to exceed the height of existing historically significant buildings in close proximity (<i>Urban Design, Policy 1.3.7</i>) 			Х						



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Campus Master Plan Checklist									
				С	OMBIN	E FOR	DESIGN	N-BUIL	D
EVALUATION CRITERIA	PROGRAMMING AND SITE SELECTION		SCHEMATIC DESIGN Concept Advanced			DEVE	١		
	YES	NO	NA	YES	NO	NA	YES	NO	NA
LAKES, VEGETATION AND LANDSCAPING COMMITTEE (LVLC) – Note: see also #8 above									
 12) The project does not reduce the size of an area in the Conservation Future Land Use (Figure 2-1, Future Land Use); OR The project mitigates the Conservation Future Land Use change per Conservation, Policy 1.4.11 	Х								
 The project mitigates the Conservation Future Land Use change per Conservation, Policy 1.4.11 The project (or any associated utilities or infrastructure) is not adjacent to or within a Conservation Future Land Use; OR The project siting, orientation and landscaping minimize visual impact on the Conservation Area, preserve native vegetation and allow a graduated transition from developed areas to Conservation Areas (Conservation Element, 1.1.4) 	Х								
14) The project minimizes impacts and conforms to the intent of the Conservation Area because the project is for new utilities or infrastructure (including exterior lighting and stormwater facilities) within a Conservation Future Land Use (Conservation, Policies 1.4.8, 1.4.9 and 1.4.10) – Note: LVLC approval recommendation required			Х						
 The project is not within 50-feet of a wetland; <u>OR</u> The project within 50-feet of a wetland minimizes impacts to wetlands and the required wetland buffers; <u>and</u> provides a minimum 35-foot setback and average 50-foot setback; <u>and</u> uses only native plants in a naturalistic landscape design within wetland buffers (<i>Conservation, Policies 1.2.1, 1.2.2, 1.2.3, 1.2.4, and 1.2.5</i>) 	Х								
 The project is not within the 100-year floodplain; <u>OR</u> The project within the 100-year floodplain addresses building elevation, compensating storage and off-site mitigation (<i>Conservation, Policy 1.2.6</i>) 	Х								
 17) The project does not disturb any plants or animals identified as threatened and endangered species or species of special concern by federal and state agencies; <u>OR</u> The project inventories such species and develops protection or relocation plans in coordination with appropriate local, state and federal agencies (<i>Conservation, Policies 1.3.2 and 1.3.3</i>) 	Х								
18) The project site does not impact an Open Space Connection identified in Figure 1-4, Urban Design Element; <u>OR</u> The project maintains, enhances or satisfactorily realigns the open space connection (<i>Urban Design, Policies 1.2.4 and 1.3.2; and Transportation, Policy 2.2.5</i>)	Х								
 19) The project site is not within or adjacent to an Open Space Enhancement Priority area identified in Figure 1-5, Urban Design Element; <u>OR</u> The project provides appropriate landscaping, hardscaping, and bicycle/pedestrian open space enhancement for the related Open Space Enhancement Priority area (<i>Urban Design, Policy 1.4.2</i>) 	Х								
20) The project integrates with existing topography and natural features (Urban Design, Policy 1.3.11)	1		Х			Х			Х



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FACILITIES PLANNING AND CONSTRUCTION

Campus Master Plan Checklist

				C	OMBIN	E FOR	DESIG	N-BUIL	D
EVALUATION CRITERIA	A SE	PROGRAMMING AND SITE SELECTION		DESIGN Concept Advanced			DEVE	ENT	
	YES	NO	NA	YES	NO	NA	YES	NO	NA
21) The project identifies any potential adverse affects, accommodates any increase in volume of runoff over the pre- development volume for a 72-hour period from the 100-year storm event, and provides a courtesy review to the City of Gainesville because the project is within the Hogtown Creek drainage basin (<i>General Infrastructure Stormwater Sub- Element, Policy</i> 1.3.5)			Х			Х			Х
22) The project use trees, plant materials, exterior furniture, paving materials and walls to reinforce spatial organization and create "outdoor rooms" in functional open space adjacent to buildings, within the Urban Park Future Land Use, and along roadways, pedestrian connections and shared-use paths depicted in Figure 1-4 (Urban Design, Policies 1.3.3 and 1.4.1)	-	-	-						
23) Stormwater retention facilities associated with the project (if any) are designed to be natural and curvilinear in outline with variable side slopes, smooth transitions to existing grade and planted with native vegetation (General Infrastructure Stormwater Sub-Element, Policies 1.2.4 and 1.2.5)	-	-	-						
24) The project incorporates Best Management Practices and Low Impact Development design to address stormwater quality and quantity including pollutants, erosion and sedimentation (General Infrastructure Stormwater Sub-Element Policies 1.3.2, 1.3.3, 1.3.4 and 1.4.1)	-	-	-						
25) The project satisfies UF Design & Construction Standards for tree protection, removal, relocation and mitigation (Urban Design, Policies 1.4.9, 1.4.10 and 1.4.12) – Note: LVLC approval recommendation required	-	-	-						
26) The project satisfies UF Design & Construction Standards for landscaping in parking lots and around buildings, and installation is concurrent with the appropriate building construction phase (Urban Design, Policies 1.4.13, 1.4.14 and 1.4.15) – Note: LVLC approval recommendation required	-	-	-						
PARKING AND TRANSPORTATION COMMITTEE (P&TC) – Note: see also #18 and #19 above									
27) The project provides a traffic engineering study with a courtesy review by UF's host local governments because the project includes a parking structure or surface with at least 300 parking spaces located in Alachua County (<i>Transportation, Policy 1.2.2 and 1.2.3</i>)			Х						
 28) The project does not result in any significant loss of existing parking; <u>OR</u> The loss of significant existing parking is mitigated - Note: Parking loss mitigation to be negotiated in consultation with the P&TC (<i>Transportation, Policy 2.6.5</i>) 	Х								
29) The project satisfies UF Design & Construction Standards for bicycle parking including quantity, location and lighting with covering as feasible (<i>Transportation</i> , <i>Policy</i> 2.2.6)	-	-	-						
30) The project provides hot water showers and lockers for use by bicycle commuters; <u>OR</u> The project demonstrates that hot water showers and lockers are infeasible (<i>Transportation, Policy 2.2.13</i>)	-	-	-						
31) The project provides adequate parking to meet the needs of disabled persons, service and delivery vehicles necessitated by the building construction project (<i>Transportation, Policy 2.6.5</i>)	-	-	-						

UNIVERSITY OF FLORIDA

NEWELL

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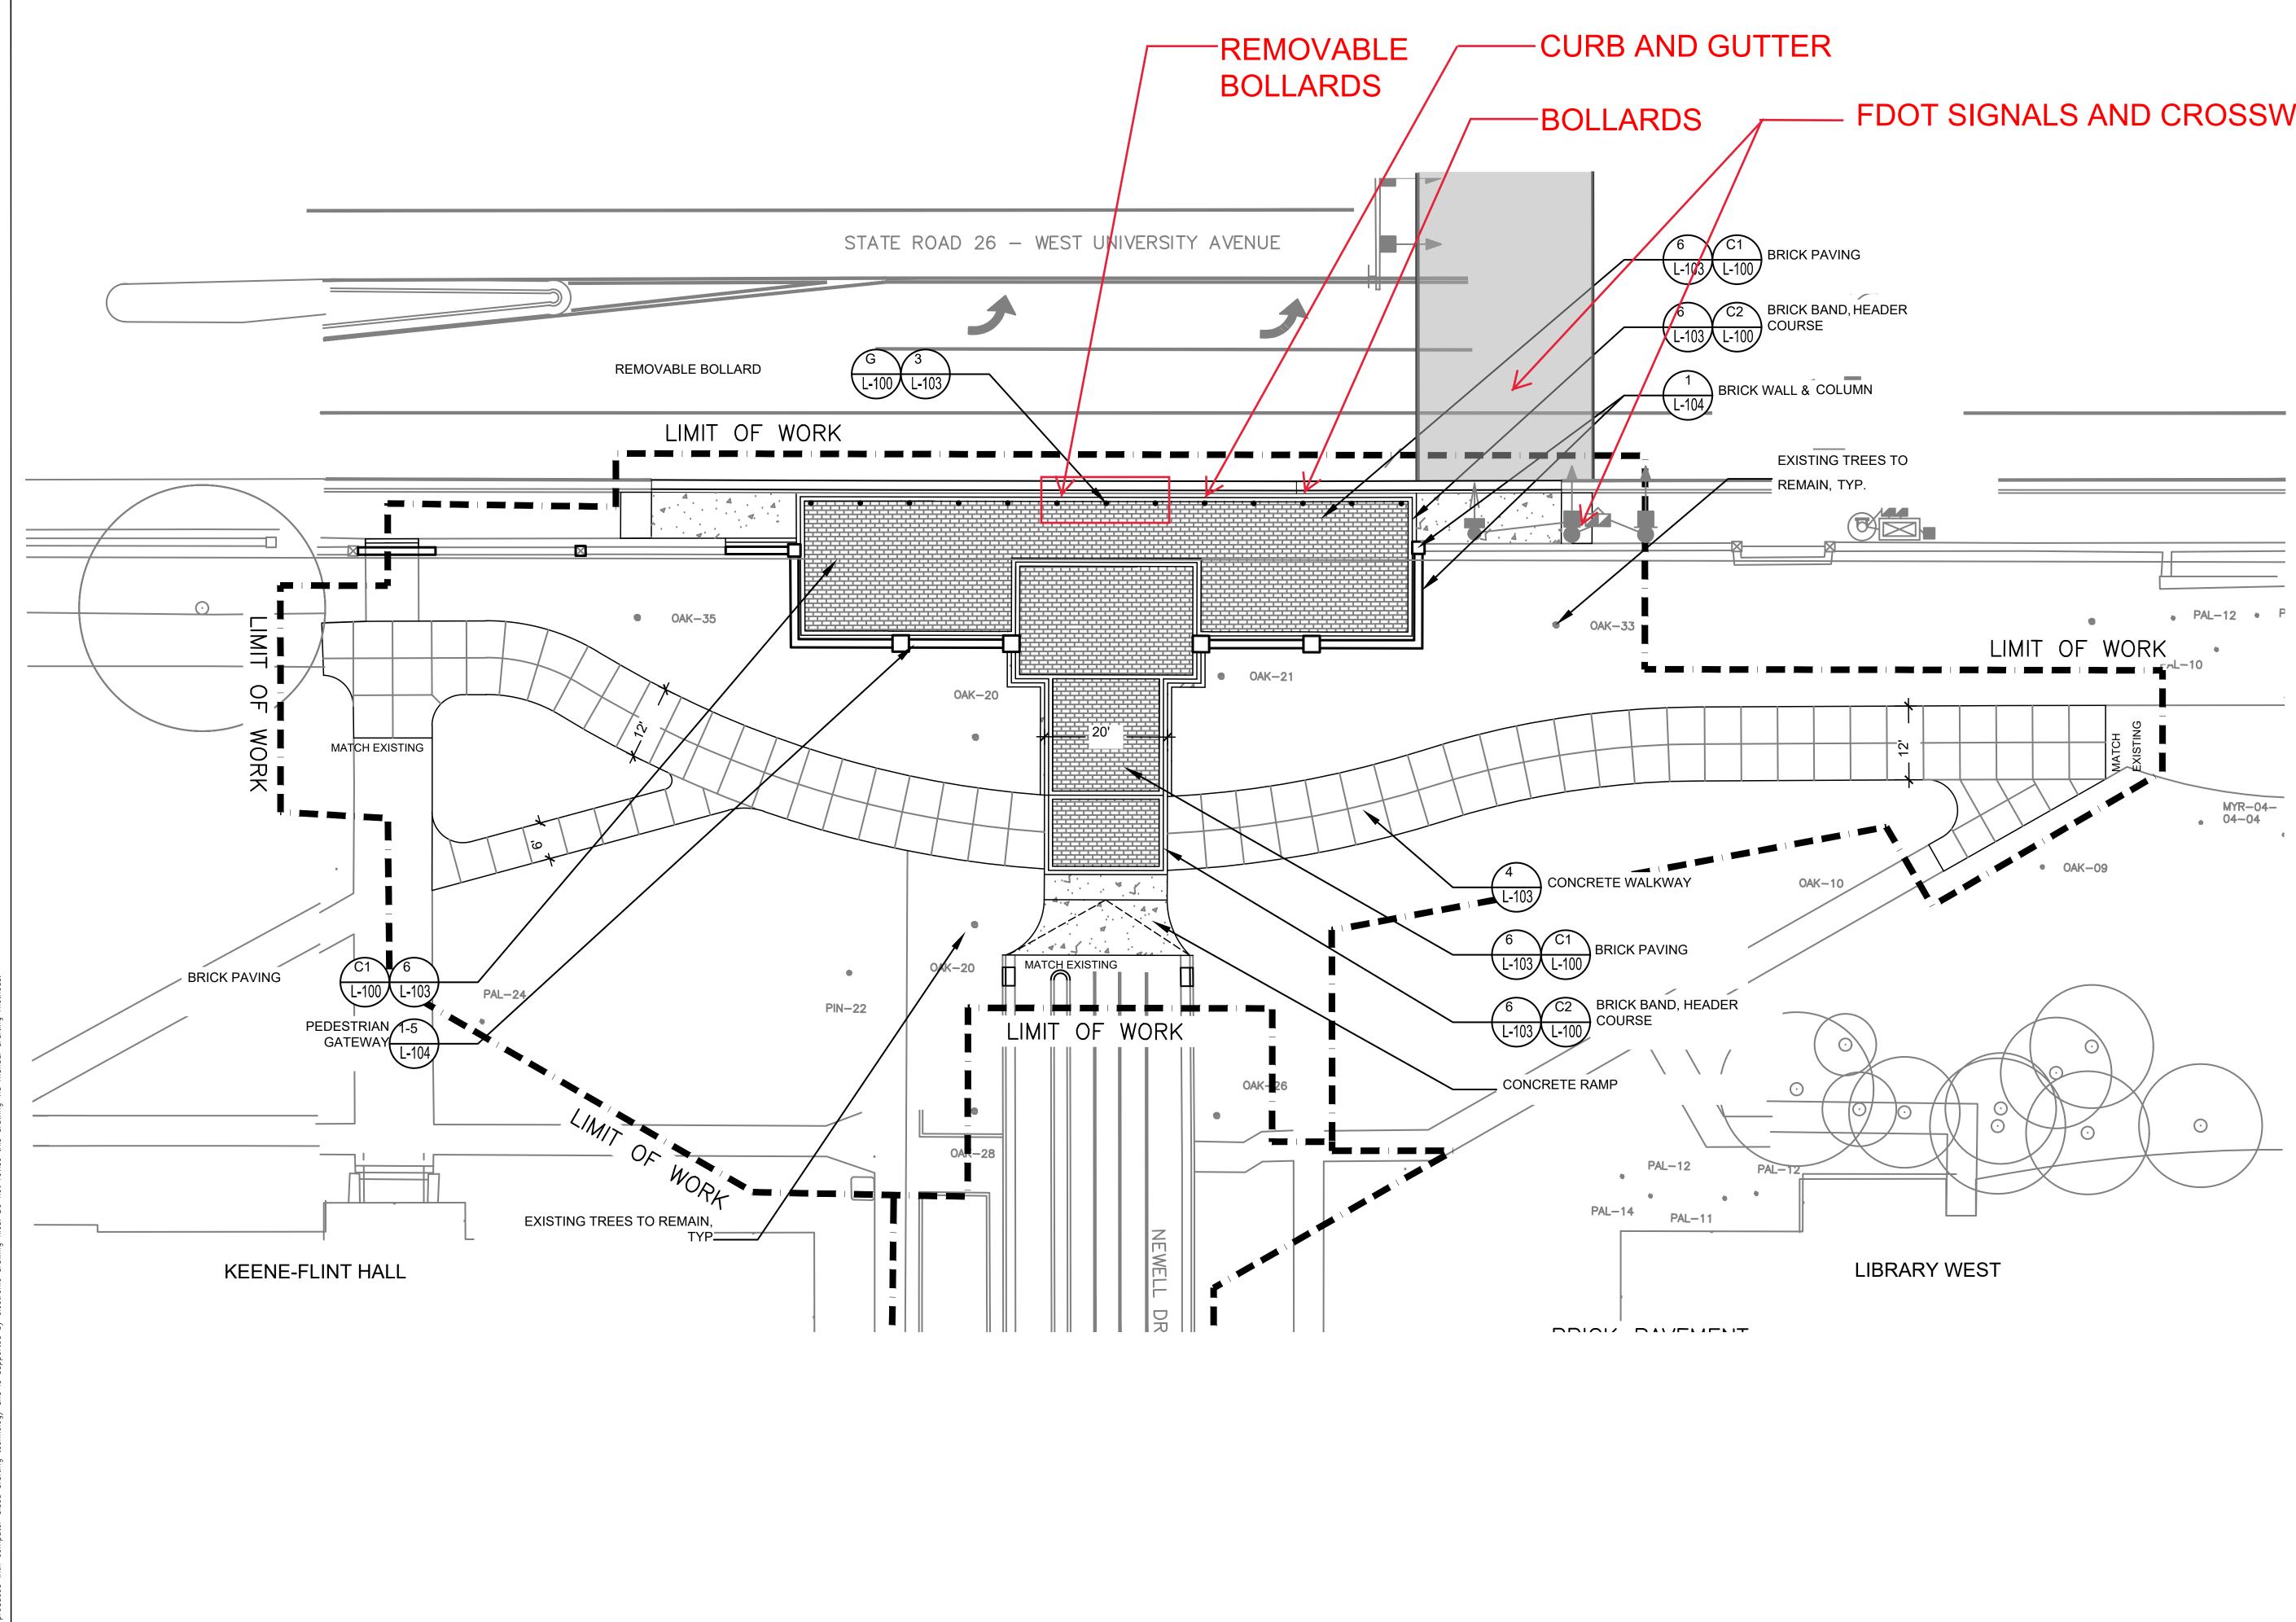
NEWELL GATEWAY











FDOT SIGNALS AND CROSSWALK

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618 E. SOUTH STREET SUITE 700 ORLANDO, FL 32801 407 423-8398 CERTIFICATE OF AUTHORIZATION: EB9951



PROJECT

UNIVERSITY OF FLORIDA

LANDSCAPE MASTER PLAN IMPLEMENTATION

UF656 GAINESVILLE, FL

DESIGN DEVELOPMENT CONSULTANTS

REGISTRATION

REVISIONS:

PROJECT NUMBER	R200265.00
SCALE:	
DATE:	01/06/2021
DRAWN:	AP
CHECKED:	FB
APPROVED:	

SCALE & NORTH ARROW



SHEET TITLE NEWELL GATEWAY HARDSCAPE PLAN SHEET NUMBER

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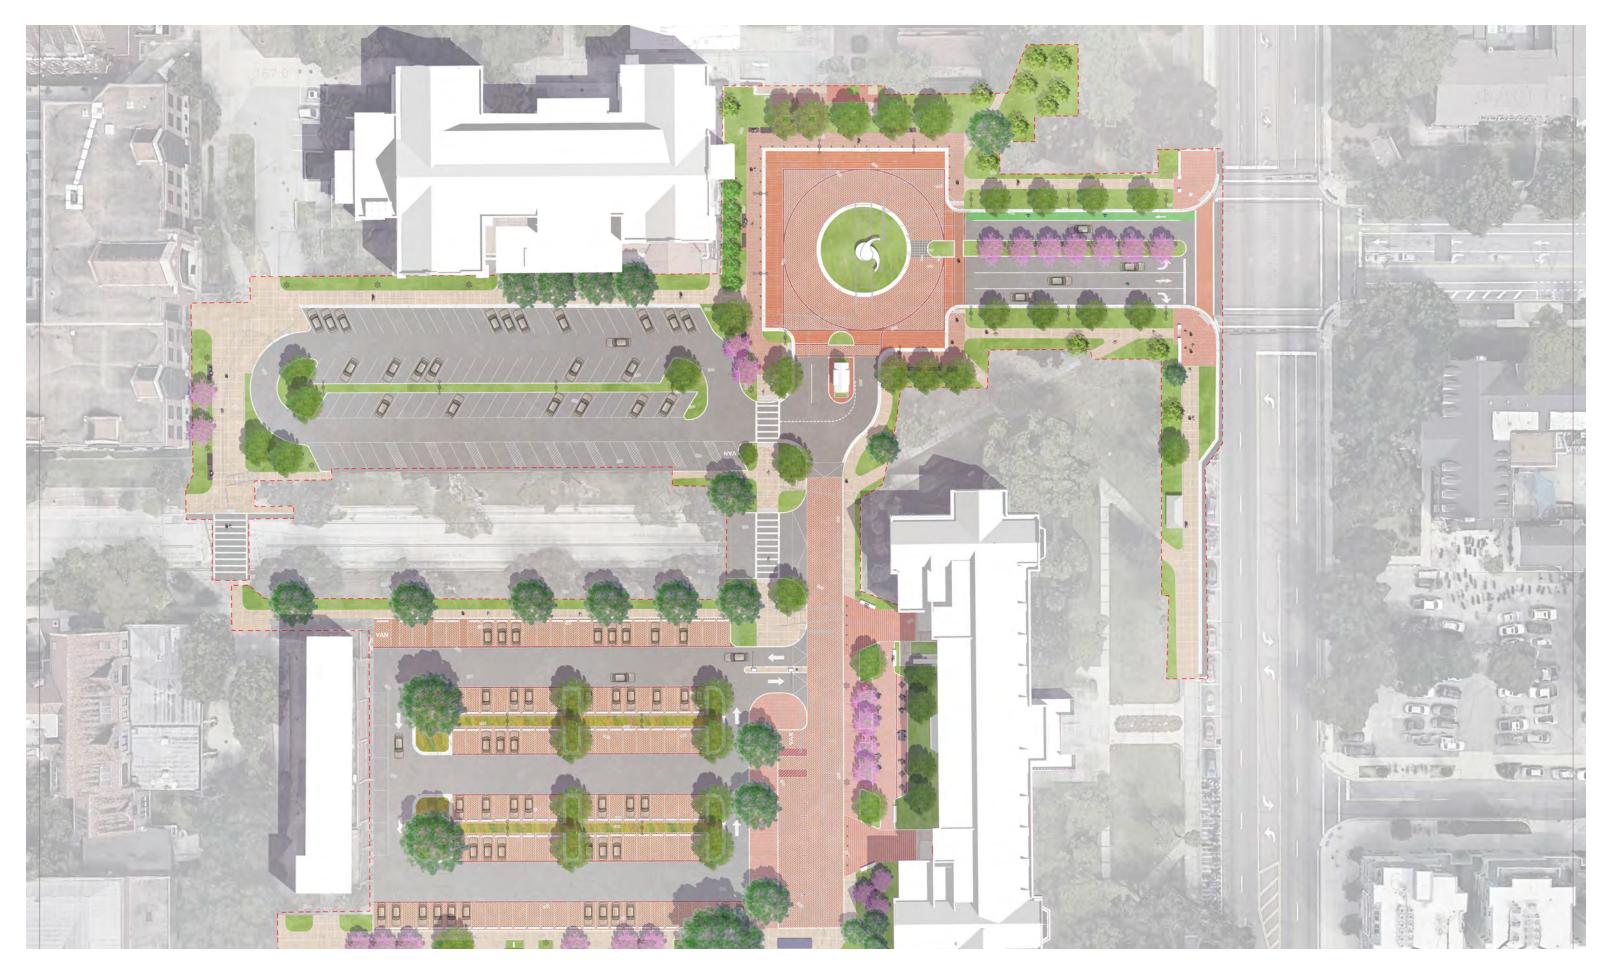


NEWELL GATEWAY PERSPECTIVE










NORTHEAST GATEWAY









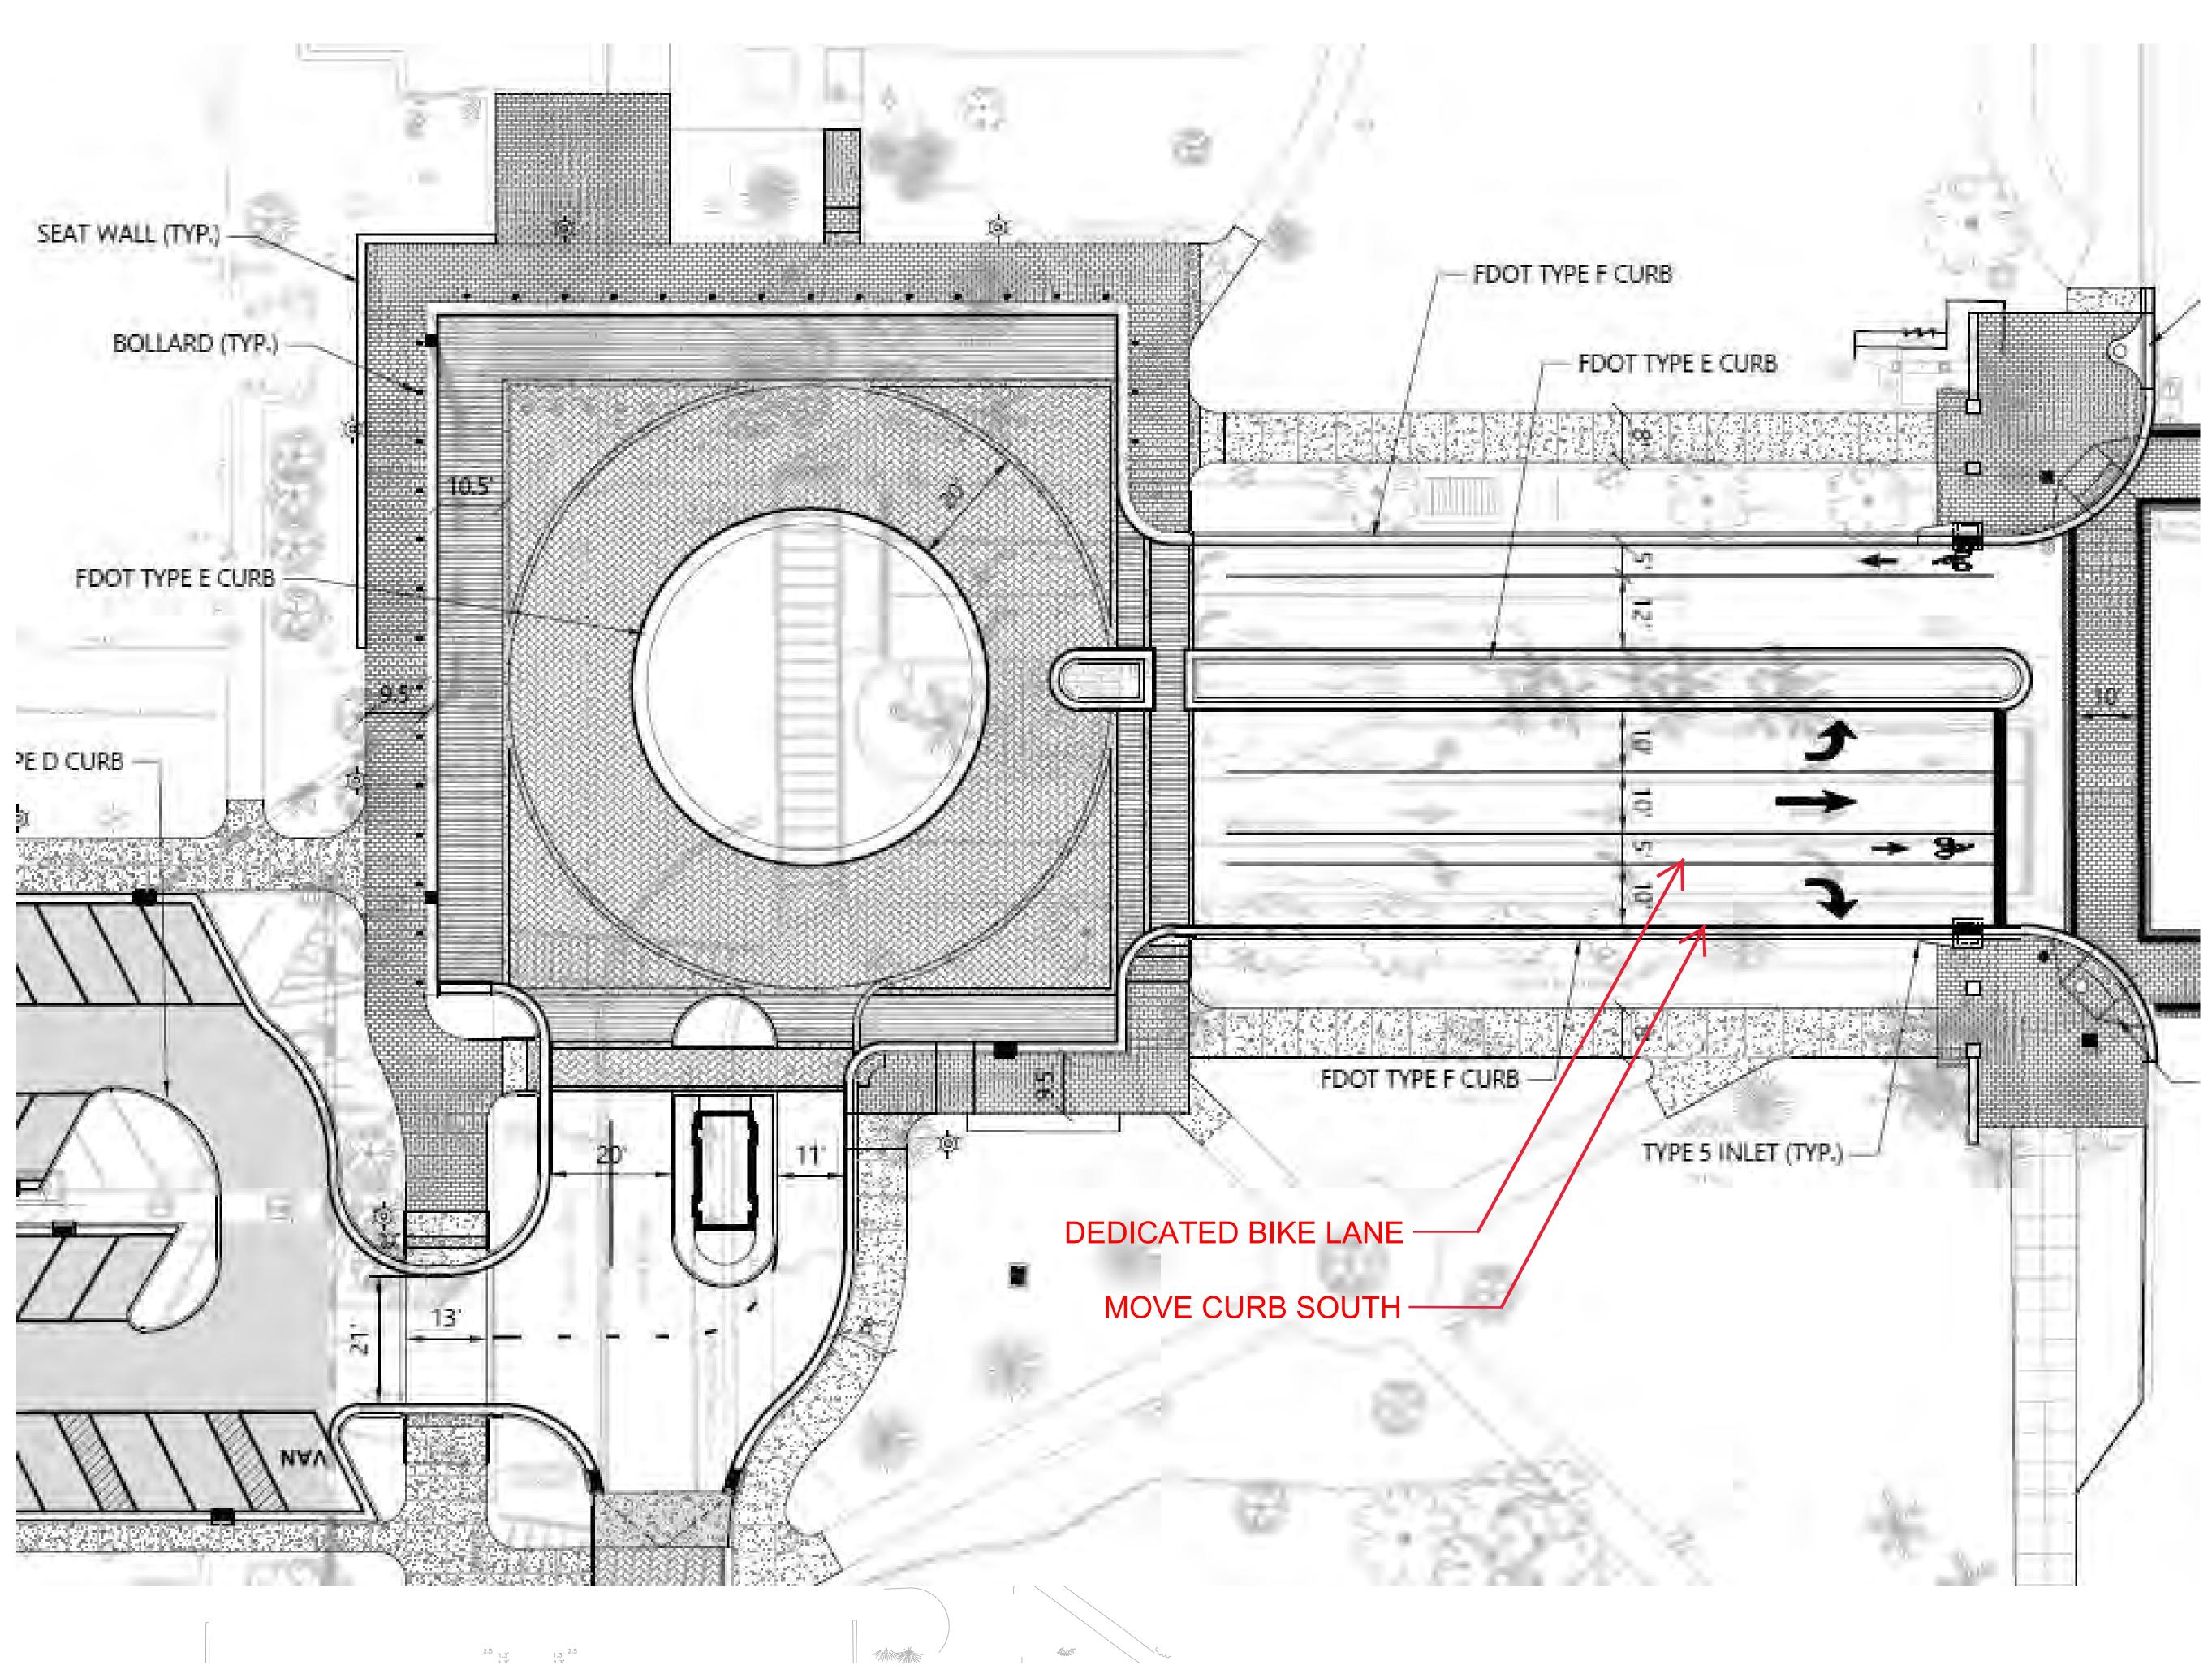

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UF FLORIDA

PROJECT UNIVERSITY OF FLORIDA

LANDSCAPE MASTER PLAN IMPLEMENTATION

UF656 GAINESVILLE, FL

DESIGN DEVELOPMENT

CONSULTANTS



REGISTRATION

REVISIONS:		
		<u> </u>
PROJECT NUMBER	R	200265.00
SCALE:		
DATE:		01/06/2021
DRAWN:		SCS
CHECKED:		JLI
APPROVED:		
SCALE & NORTH ARROW		

SHEET TITLE

NORTHEAST GATEWAY REVISED ENTRANCE SHEET NUMBER





NORTHEAST GATEWAY - ENTRANCE

NORTHEAST GATEWAY *perspectives*



CAMPUS - STANDARD LIGHT - BRICK ENTRY WALL & PIER

BRICK PAVEMENT FLOWERING TREES & ISLAND PLANTING

PROPOSED








NORTHEAST GATEWAY - AUTOCOURT


NORTHEAST GATEWAY *perspectives*







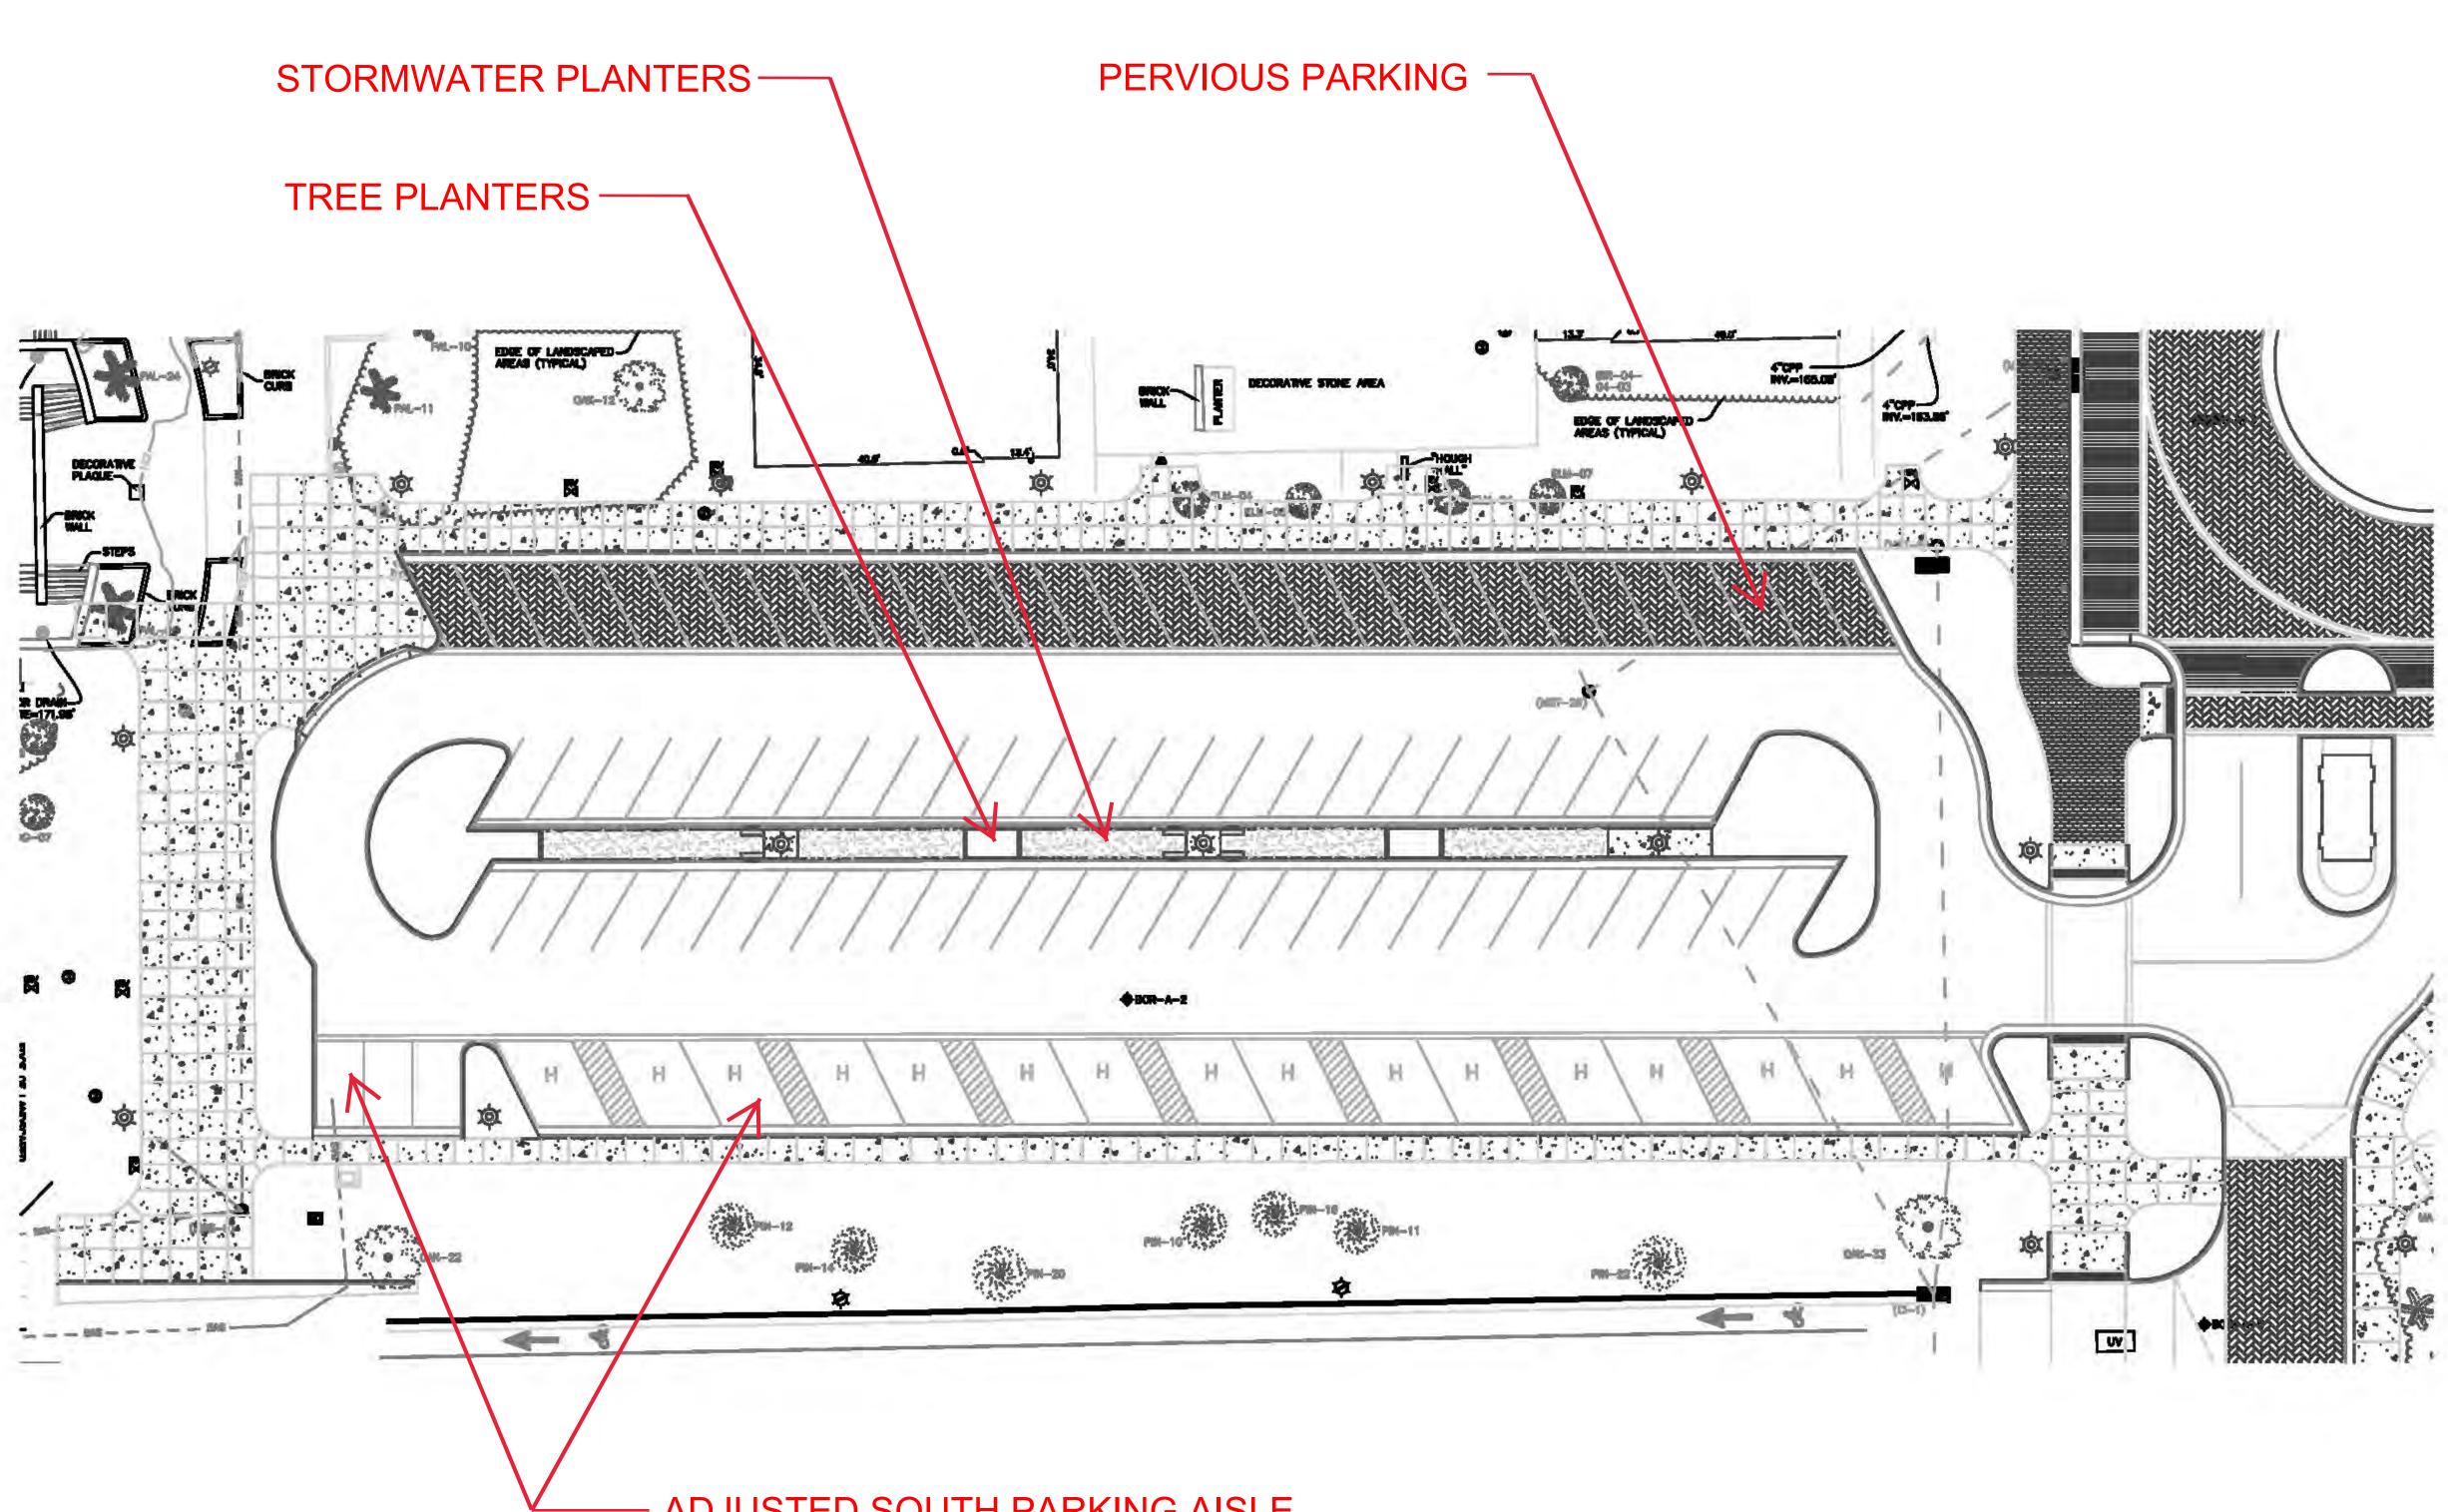

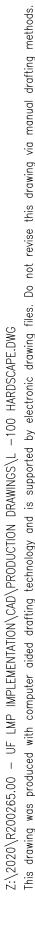

ADJUSTED SOUTH PARKING AISLE

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LANDSCAPE MASTER PLAN IMPLEMENTATION

UF656 GAINESVILLE, FL

DESIGN DEVELOPMENT CONSULTANTS

REGISTRATION

REVISIONS:


PROJECT NUMBER	R200265.00
SCALE:	
DATE:	01/06/2021
DRAWN:	AP
CHECKED:	FB
APPROVED:	

SCALE & NORTH ARROW

SHEET TITLE **CRISER PARKING** LAYOUT PLAN

SHEET NUMBER L-101

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2:/2020/R200265.00 — UF LMP IMPLEMENTATION/CAD/PRODUCTION DRAWINGS/L —100 HARDSCAPE.DWG This drawing was produced with computer aided drafting technology and is supported by electronic drawing files. Do not revise this drawing via manual drafting me
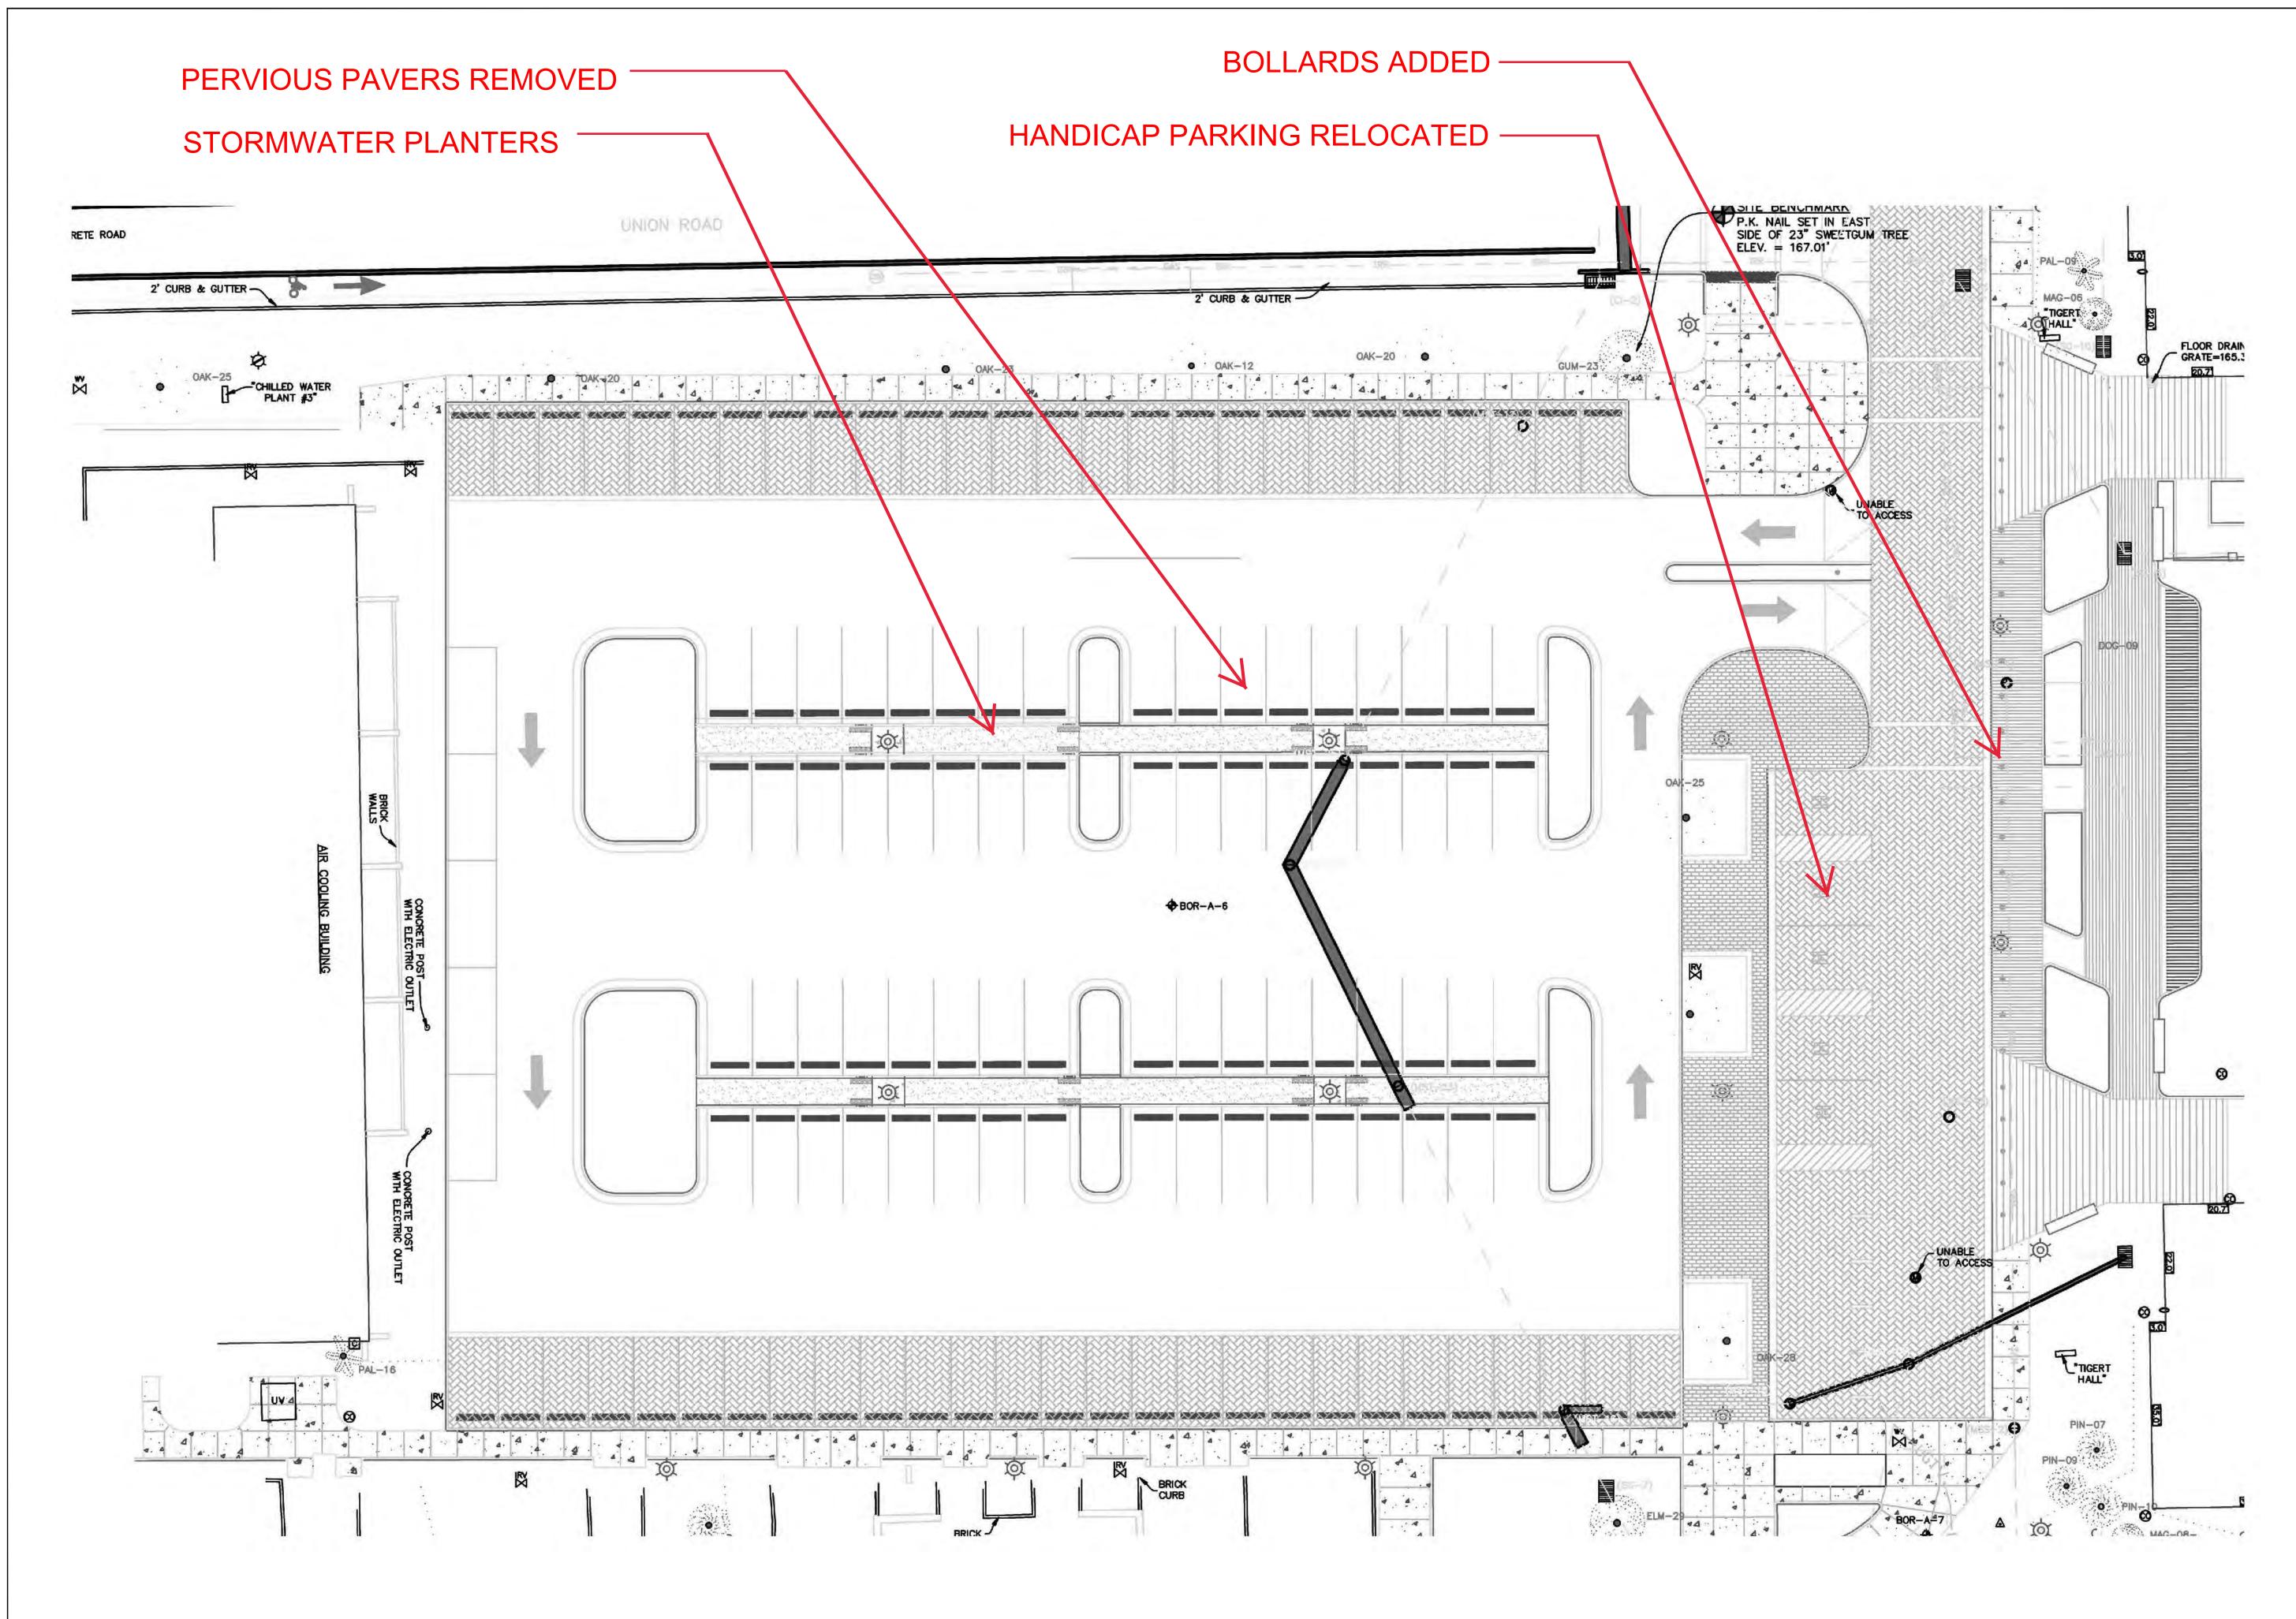
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UF FLORIDA

PROJECT

UNIVERSITY OF FLORIDA

LANDSCAPE MASTER PLAN IMPLEMENTATION

UF656 GAINESVILLE, FL

DESIGN DEVELOPMENT

CONSULTANTS

REGISTRATION

REVISIONS:		-
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SCALE.	
DATE:	01/06/2021
DRAWN:	AP
CHECKED:	FB
APPROVED:	

SCALE & NORTH ARROW

SHEET TITLE LITTLE PARKING LAYOUT PLAN

SHEET NUMBER




NORTHEAST GATEWAY - GATHERING SPACE AT TIGERT HALL



NORTHEAST GATEWAY PERSPECTIVES





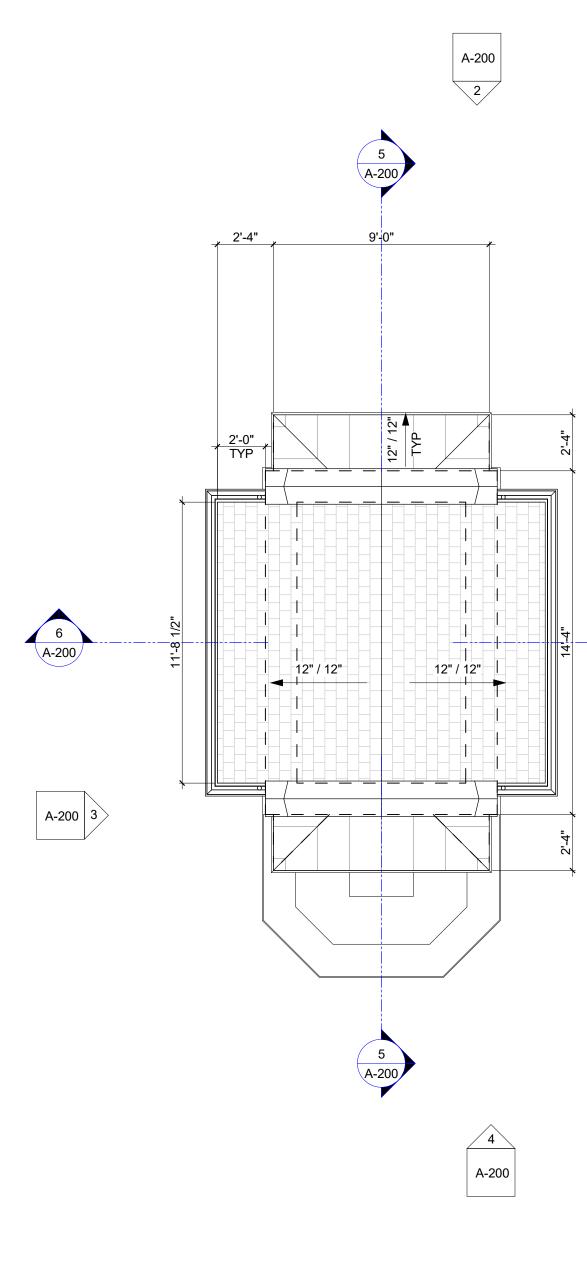

1 A-200

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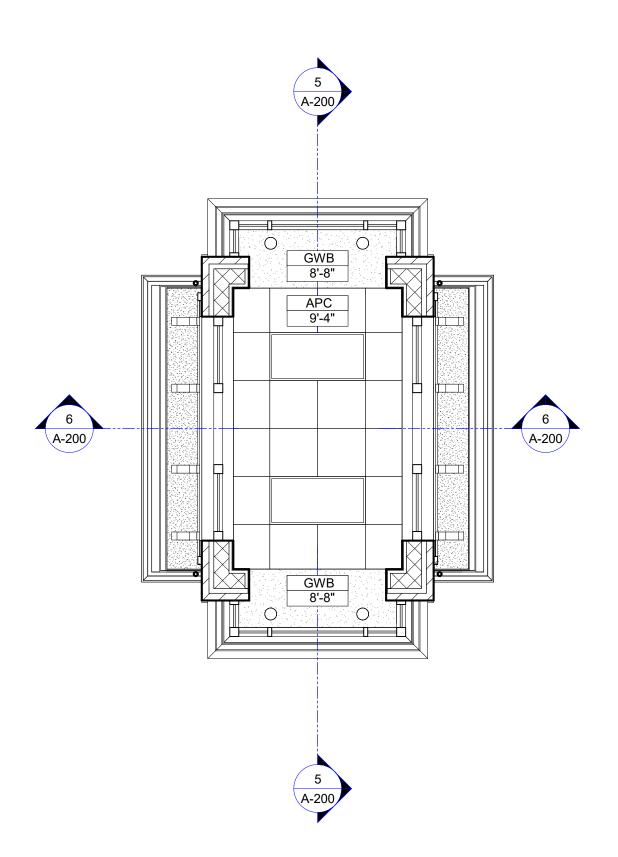
A-200

ROOF PLAN 3 1/4" = 1'-0"

ROOF PLAN SHEET NOTES

1. XXXXXXX

KEYNOTE LEGEND



CEILING PLAN (2) 1/4" = 1'-0"

CEILING PLAN SHEET NOTES

- 1. CEILING ELEMENTS (LIGHTS, GRILLS, ETC...) SHOWN FOR LOCATION AND
- COORDINATION. 2. COORDINATE LOCATION, SIZE, AND REQUIREMENTS OF CEILING ELEMENTS WITH
- M/E/P/F DOCUMENTS. 3. SUSPENDED TILE CEILING GRIDS SHALL BE SET WITH EITHER A FULL TILE OR A GRID INTERSECTION OCCURRING AT THE CENTER OF THE CEILING EXPANSE SO AS TO ACHIEVE TILES OF EQUAL WIDTH AT OPPOSING SIDES OF THE CEILING. NO CEILING GRID CONFIGURATION SHALL RESULT IN A TILE AT ANY PERIMETER
- EDGE OF LESS THAN 4 INCHES IN WIDTH. 4. IMMEDIATELY BRING DISCREPANCIES TO THE ARCHITECT'S ATTENTION.
- 5. IN ACOUSTICAL PANEL CEILINGS, CENTER CEILING ELEMENTS IN PANELS. 6. IN GYPSUM WALL BOARD CEILINGS ALIGN CEILING ELEMENTS WITH ADJACENT CEILING ELEMENTS.
- PROVIDE ACCESS PANELS IN NON-ACCESSIBLE CEILINGS (SUCH AS GYPSUM BOARD) WHERE REQUIRED FOR ACCESS TO SERVICEABLE MECHANICAL, ELECTRICAL, OR PLUMBING DEVICES. PROVIDE COORDINATED ACCESS PANEL LOCATION SHOP DRAWING FOR REVIEW AND APPROVAL BY ARCHITECT PRIOR TO INSTALLATION.

CEILING LEGEND

CEILING TAG	APC-1	CEILING FINISH HEIGHT AFF	
RECESSED DOWNLIGHTS	0	2'x2' CEILING GRID	
1'x4', 2'x4' & 2'x2' RECESSED LIGHT FIXTURE		GWB CEILING	
HVAC TERMINALS			




- THE FOLLOWING CRITERIA:
- COLUMN).

FINISHES NOTES

- INDICATED.

FINISH ABBREVIATIONS AND CODES

CODE FINISH APC CPT PAINT RB RF SCONC SSM TILE WD WOOD WS

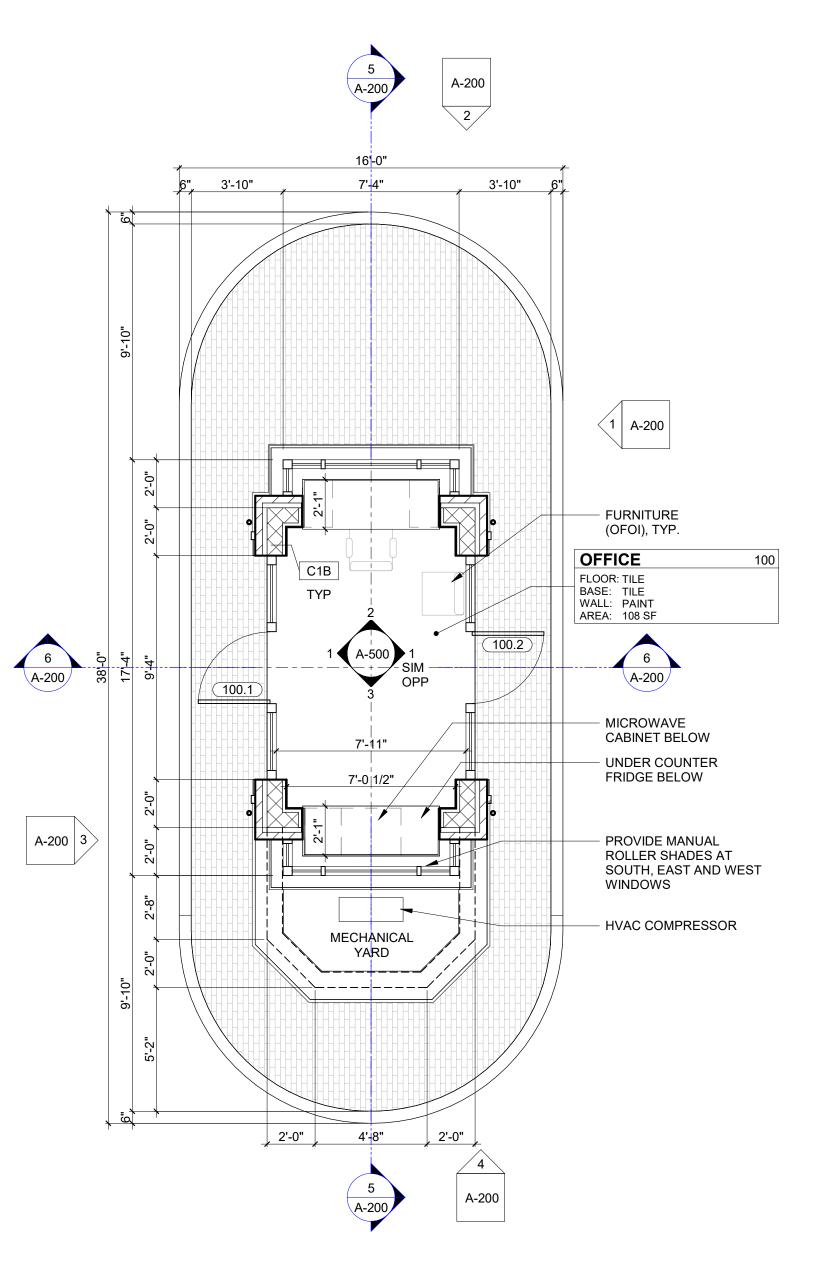

FLOOR PLAN NOTES

1. SEE WALL SECTIONS FOR EXTERIOR WALL ASSEMBLY INFORMATION. . PROVIDE IN WALL BACKING FOR WALL MOUNTED ITEMS. 3. PARTITIONS NOT DIMENSIONED ARE GENERALLY LOCATED BY ONE OF

A. CENTERLINE - CENTER OF PARTITION ALIGNS WITH A STRUCTURAL GRIDLINE OR OBJECT CENTERLINE (SUCH AS WINDOW MULLION OR

B. ALIGN - LOCATE PARTITION FLUSH WITH FACE OF GYPSUM BOARD OR OTHER SURFACE INDICATED

C. MAINTAIN DIMENSIONS NOTED AS "MINIMUM" OR "CLEAR" 4. PROVIDE MINIMUM 1'-0" CLEAR AT PUSH SIDES OF DOORS AND 1'-6" CLEAR AT PULL SIDES OF DOORS UNLESS INDICATED OTHERWISE.

1. AREAS SHOWN IN ROOM IDENTIFICATION TAGS ARE FOR REFERENCE ONLY. DO NOT USE THESE AREAS FOR TAKE-OFFS.

2. PAINT ALL WALL SURFACES, SOFFITS, AND CEILINGS UNLESS OTHERWISE 3. PAINT ALL MECHANICAL AND ELECTRICAL EQUIPMENT EXPOSED IN FINISHED SPACES UNLESS OTHERWISE INDICATED.

> ACOUSTIC PANEL CEILING CARPET TILE HIGH PRESSURE LAMINATE RESILIENT BASE **RESILIENT FLOORING** SEALED CONCRETE SOLID SURFACE MATERIAL

WINDOW SHADE

COMMUNITY SOLUTIONS GROUP

618 E. SOUTH STREET SUITE 700 ORLANDO, FL 32801 407 423-8398 CERTIFICATE OF AUTHORIZATION: EB9951



PROJECT UNIVERSITY OF FLORIDA

LANDSCAPE MASTER PLAN IMPLEMENTATION

UF656 GAINESVILLE, FL

DESIGN DEVELOPMENT



2035 NW 13TH STREET GAINESVILLE, FL 32609 T: 352.672.6448 www.walker-arch.com AA26002009

REGISTRATION

JOSEPH B. WALKER, AIA LICENSE NO.: AR0017272

REVISIONS

Description	00-00-0
	I

PROJECT NUMBER	R200265.00
SCALE:	REFER TO DRAWINGS
DATE:	01/06/2021
DRAWN:	JMO
CHECKED:	AR

NORTH ARROW

APPROVED:

SHEET TITLE FLOOR, CEILING & ROOF PLANS



EXTERIOR ELEVATION SHEET NOTES




KEYNOTE LEGEND


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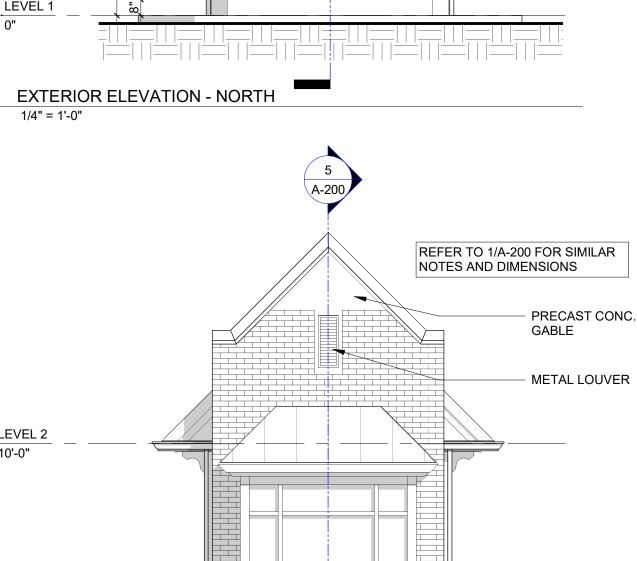








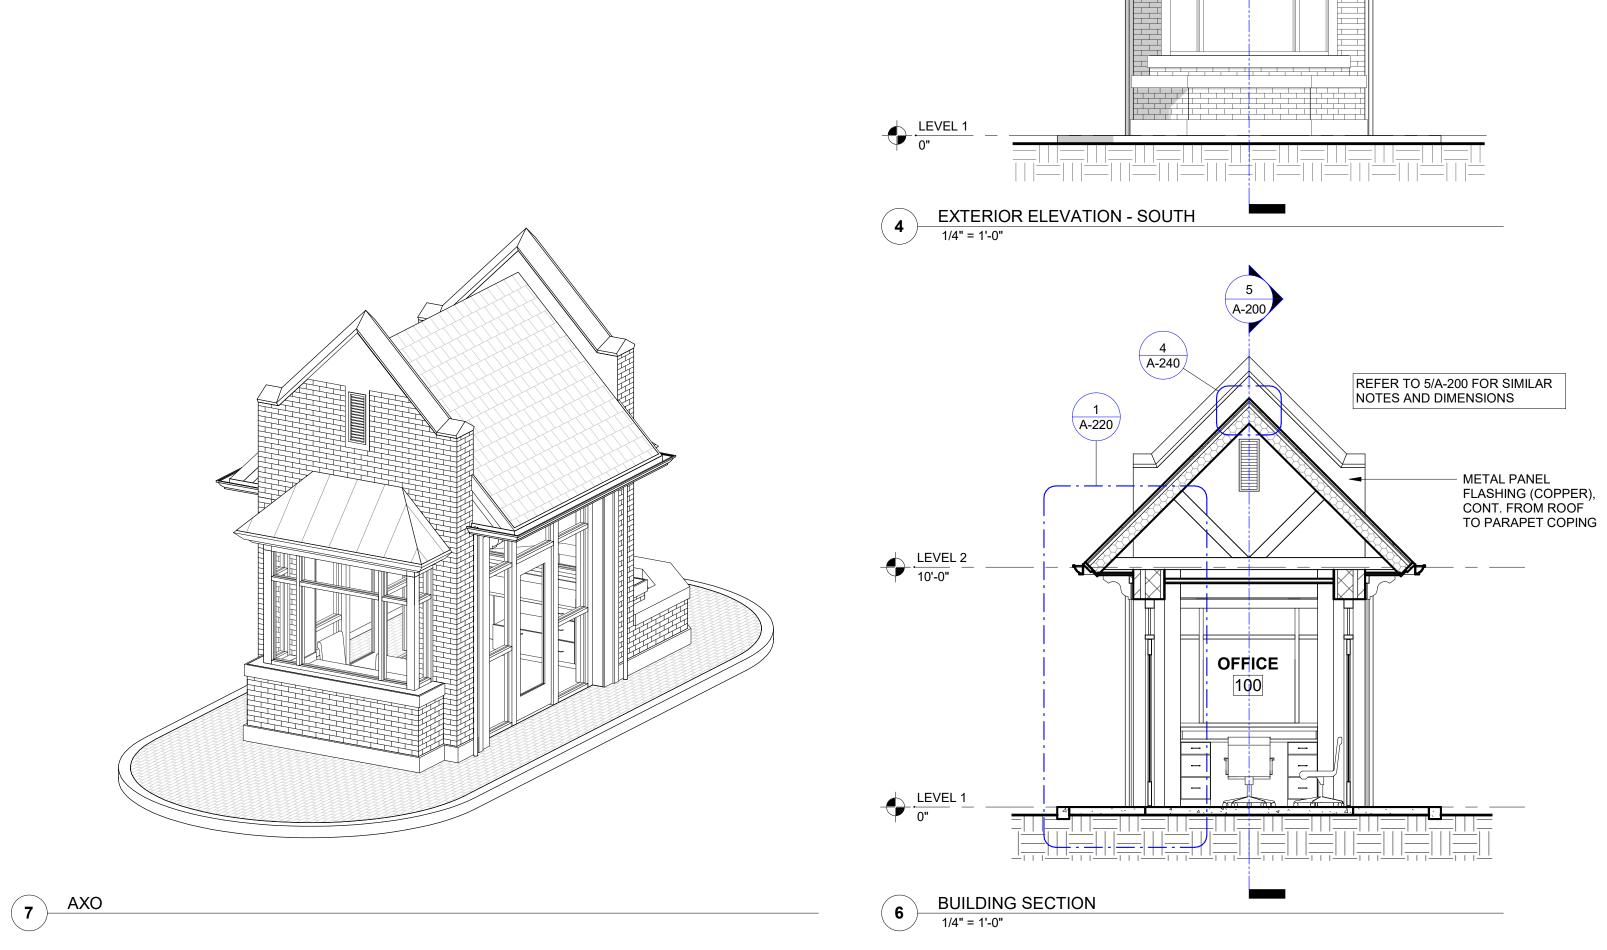



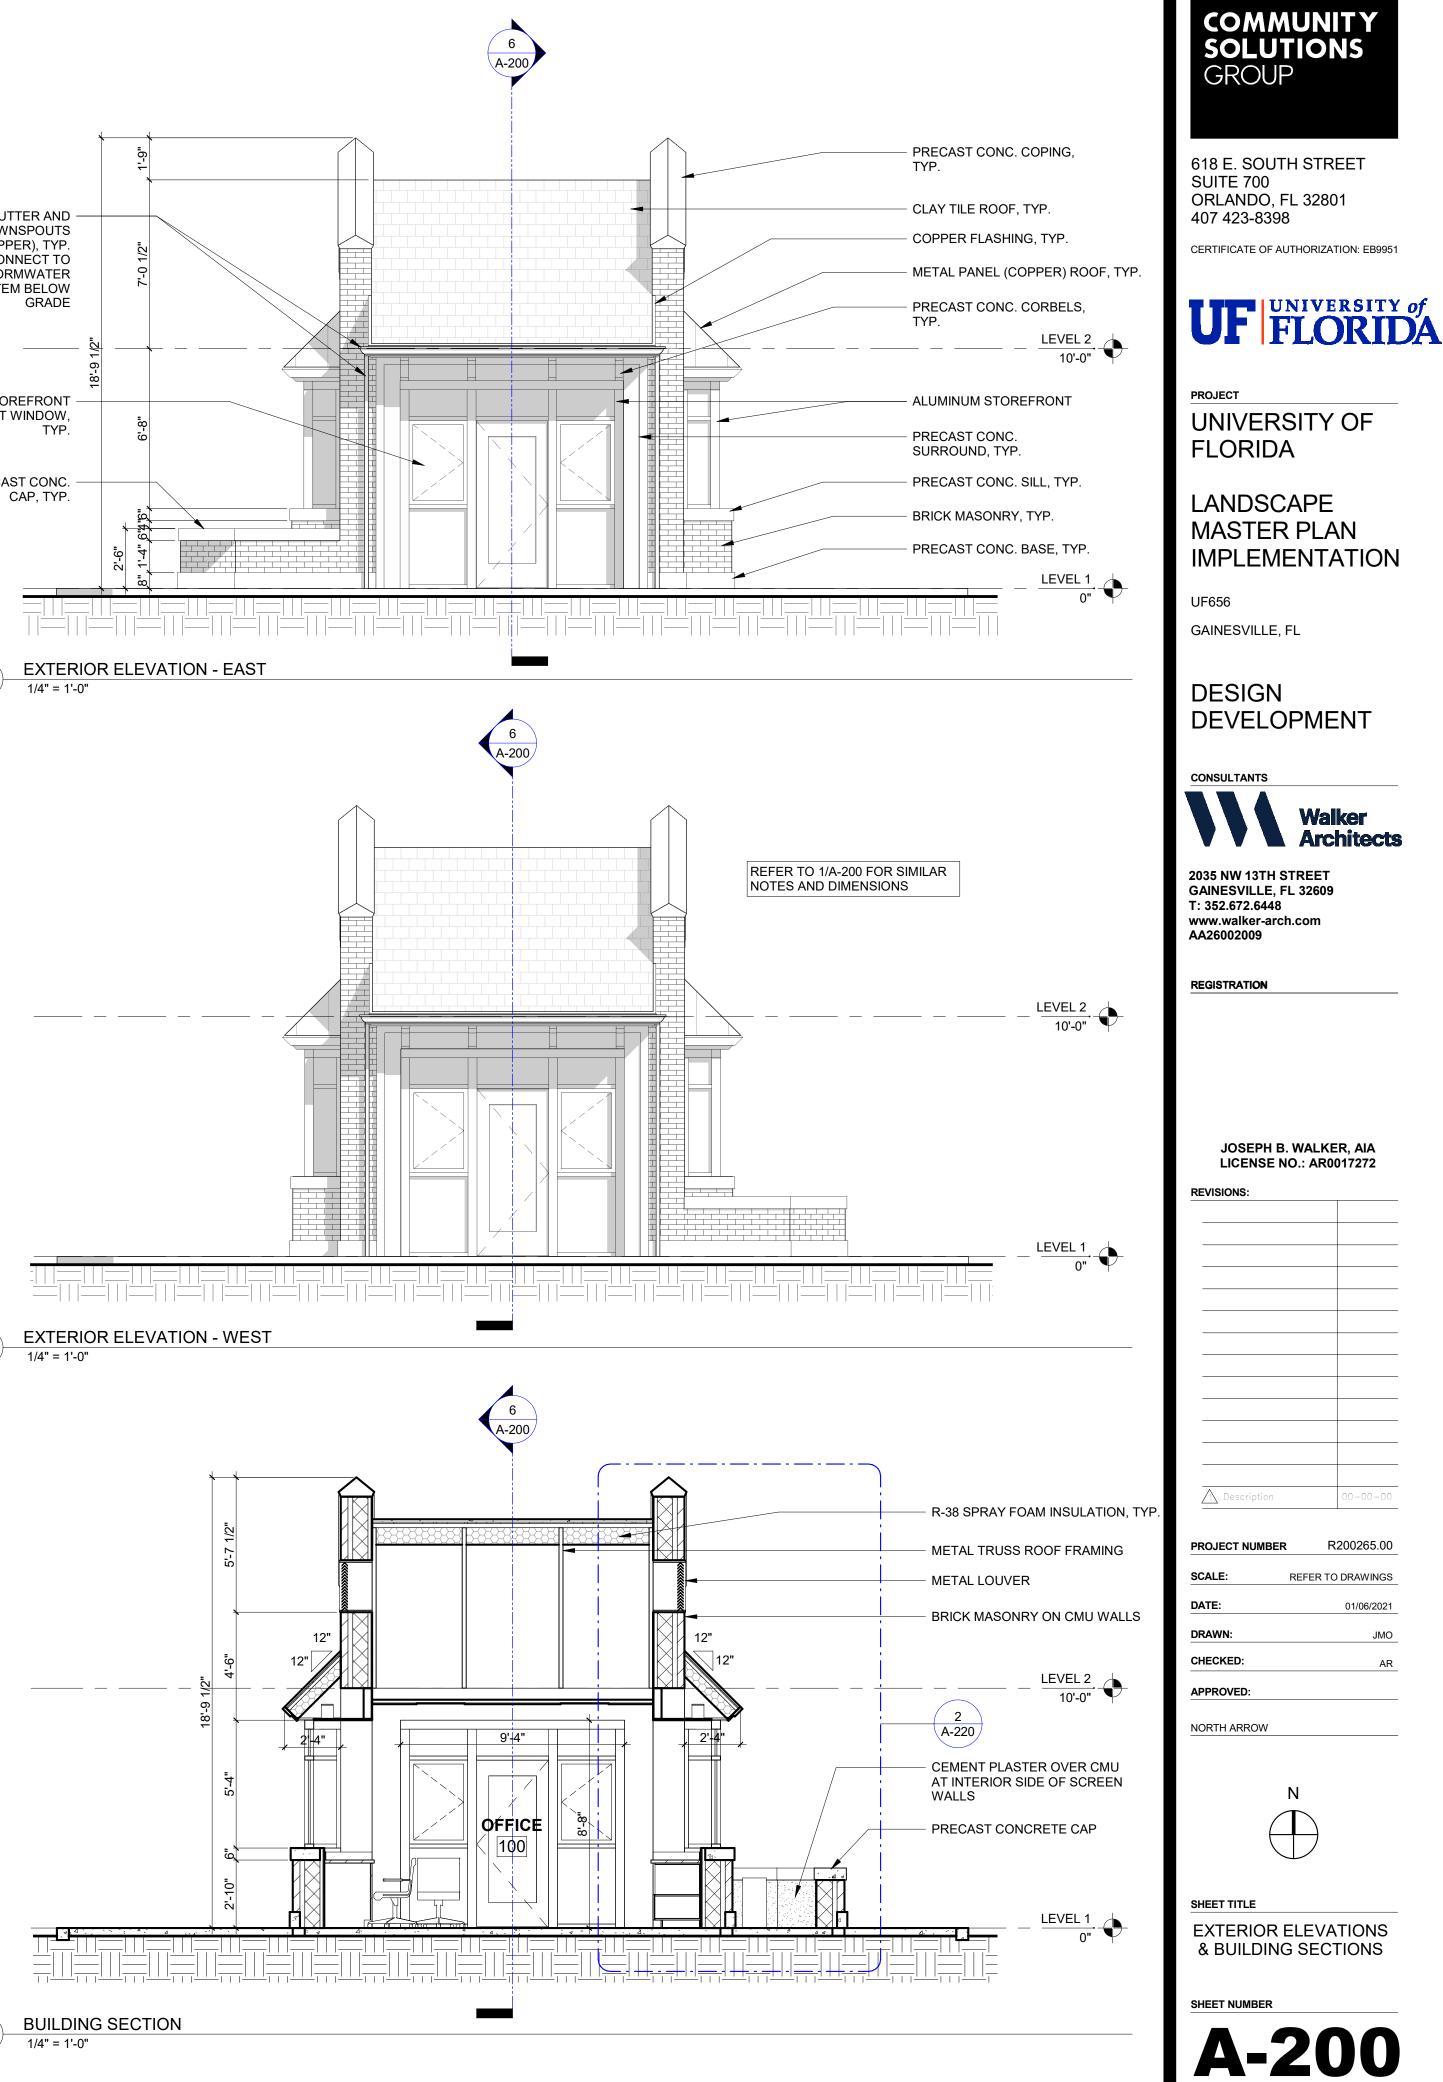

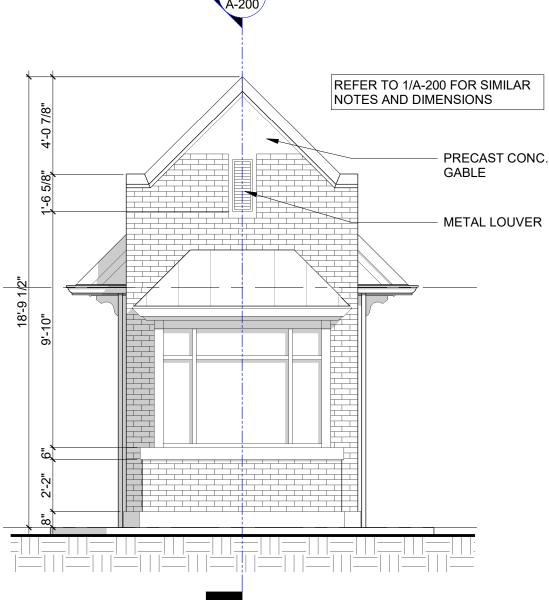

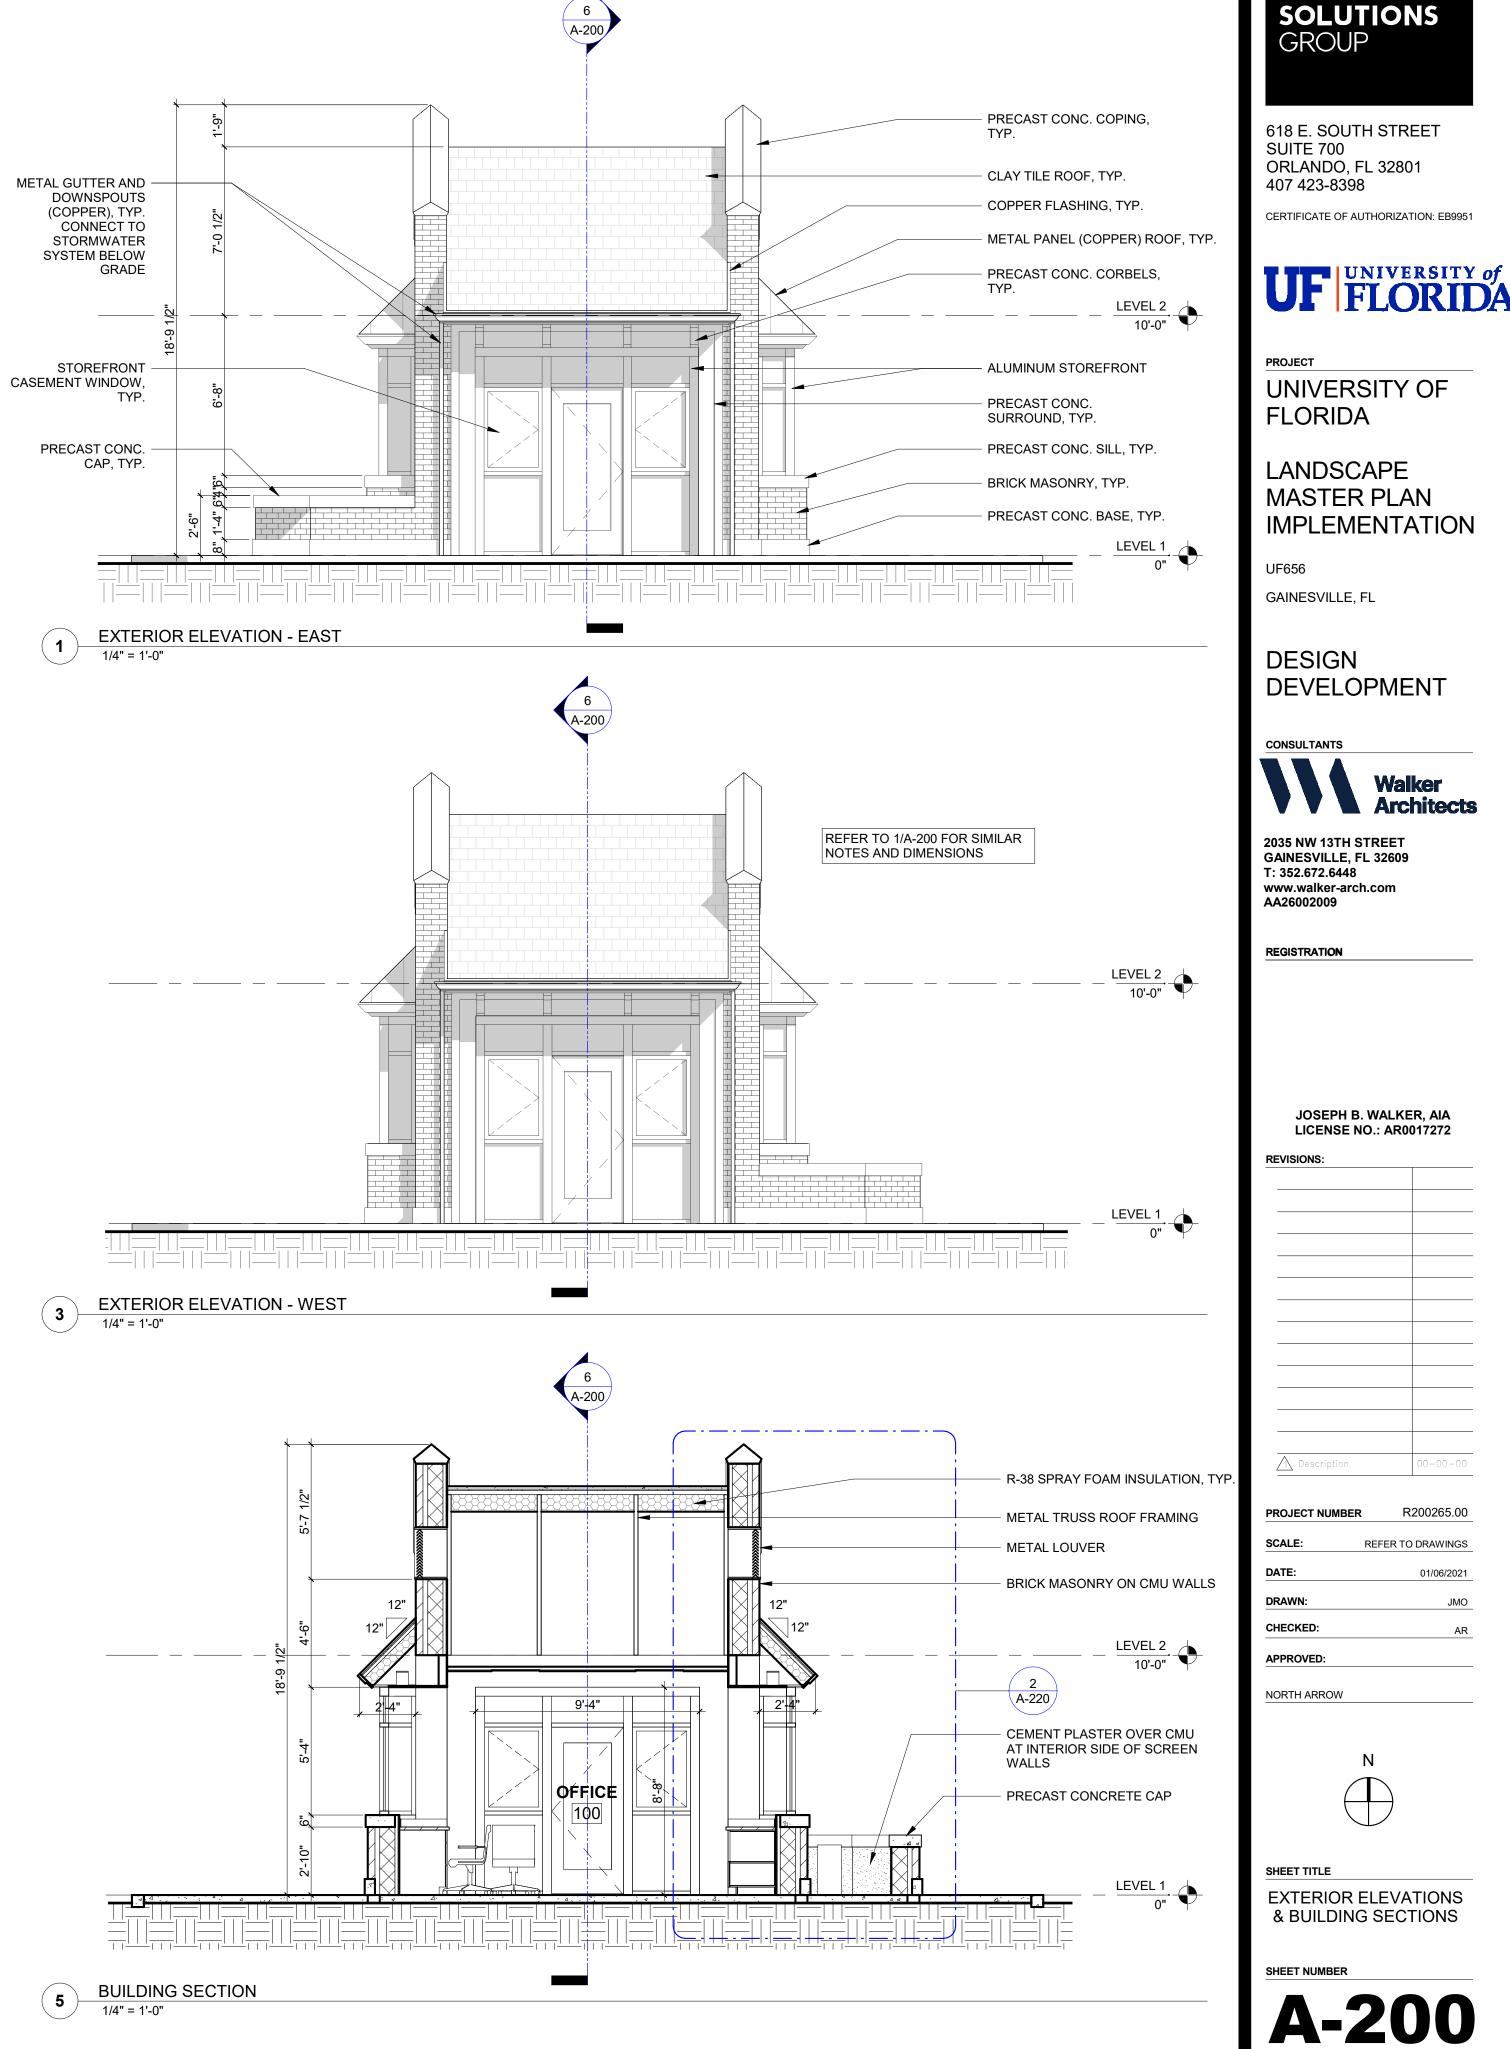

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NORTHEAST GATEWAY - GUARDHOUSE





DECEMBER 02, 2020







MP03484 Sigma Alpha Epsilon Weight Room Addition

The Rickman Partnership, Inc. February 2021

Existing Conditions




Existing Conditions






Existing Conditions

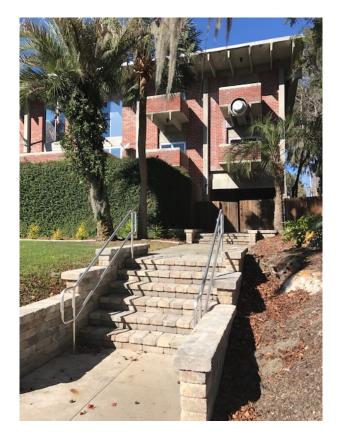





Proposed Plan

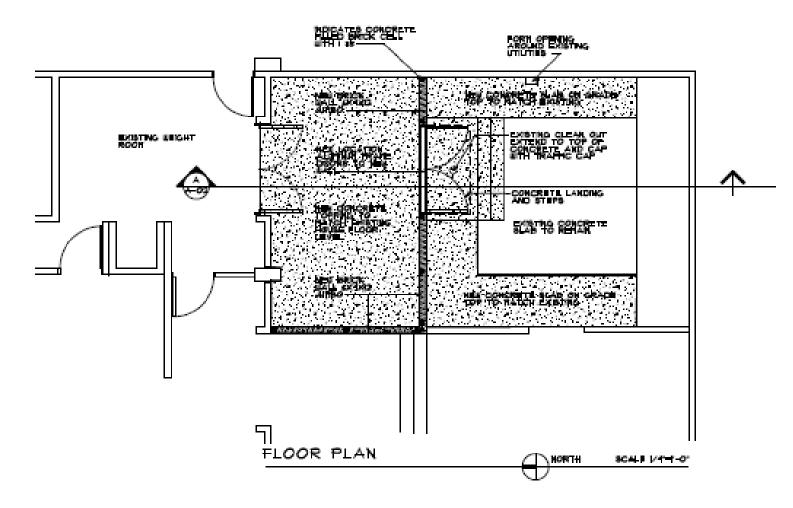

Proposed Elevations

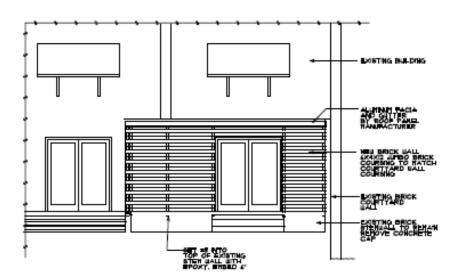

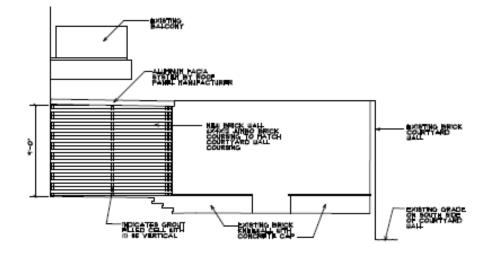

SOUTH ELEVATION

SC41 1/4"-1-0"

WEST ELEVATION SCALE VIEW -0"

MP03484 - Sigma Alpha Epsilon Weight Room Addition

EXISTING TREE RATING CRITERIA

No.	Ranking	Description
5	Good	Excellent specimen with even and lush canopy; no visible external injuries; no root circling/injury
4	Average	Overall and consistently full canopy; few if any minor external injuries or root issues
3	Fair	Uneven or partially impacted canopy; minor injuries; minor root circling/injury
2	Poor	Canopy not thriving or partially dead; numerous epiphytes or evidence of parasitic plants; injuries
1	Very Poor	Mostly dead; major injury; root circling

Tree No.	Scientific Name	Common Name	DBH	Rating	Remove	Remain	Mitigation	Replacen Trees
231	Sabal palmetto	Sabal Palm	16	4	Х		2:1	2
-232	Sabal palmetto	Sabal Palm	21	4	X		2:1	2
233	Pinus taeda	Lobioliy Pine	17.5	3	×		2.1	2
234	Sabal palmetto	Sabal Palm	17	3	X		2:1	2
236	llex x attenuata 'East Palakta'	East Palatka Holly	10	3	х		2:1	2
237	llex x attenuata 'East Palakta'	East Palatka Holly	7	3	х		2:1	2
238	llex x attenuata 'East Palakta'	East Palatka Holly	9	3	х		2:1	2
256	Pinus taeda	Loblolly Pine	20	4	х		2:1	2
257	Quercus virginiana	Live Oak	10	3	х		2:1	2
258	Quercus virginiana	Live Oak	9	3	х		2:1	2
259	Quercus virginiana	Live Oak	11	3	х		2:1	2
260	Quercus virginiana	Live Oak	10	3	х		2:1	2
261	Quercus virginiana	Live Oak	10	3	х		2:1	2
262	Quercus virginiana	Live Oak	11	3	х		2:1	2
263	Pinus taeda	Loblolly Pine	16	4	х		2:1	2
266	Pinus taeda	Loblolly Pine	16	3	х		2:1	2
				Т	IGERT GATE	WAY TOTA	L MITIGATION:	145 -

DECEMBER 02, 2020



ement es	Notes
	To Remain
	To Remain
	To Remain
5 - 175	replacement trees





